

+All dimensions are shown in mm unless otherwise specified. +Drawings are not to be scaled. Only figured dimensions to be used. +The contractor must check and verify all dimensions on site before

commencement of any work. <u>CONSTRUCTION</u>
+ Damp proof course must be provided under all external walls at grade. DPC to be minimum 150mm above ground level.

+ All soils under slab and around external foundation to be treated for termite control. + Window sills must be finished before internal plastering. **CIVIL WORKS**

treated with anti- termite pesticide AND should be executed bylicensed and duly registered sub contractor. +Sample for pipe works and other materials for road works specified to be presented to the engineer before works commences. +All levels for sewer and road works must be approved by the engineer before work commences.

STRUCTURAL

+This drawing must be read in conjunction with related architectural drawing, engineers and any other relevant drawings. +Concrete to be class 20/20 (1:2:4).

+Steel reinforcement bar to be:"Y" = high tensile steel to B.S 4461. "R" = Round mild steel to B.S 449. +All timber to be sawn cypress G.S grade to KS 02- 771:1989 and seasoned to equilibrium moisture content between 9% and 15%. +All timber to preservative treated in accordance with KS 02

+Depth of the foundation to be determined on site to S.E's approval.

MECHANICAL

+Pipe dimensions are in mm. +Cold water device pipes steel, with class B to B.S 1387. +Draining pipe above ground shall upvc grey while those below ground shall be upvc

+All underground foul and waste drain pipes shall be upvc to comply. +All inspection chambers covers and framing shall be cast iron to comply with BS497

+The storm water pipe to comply with BS 556. +Minimum slope in the drain to be 1%.

+All testing of pipes must be completed before plastering.

+All conduits must be laid before plastering. +General conditions of contract for sub contract works. +Government electrical specification number 1. +Government electrical specification number 2. +Electrical act and rules made there under.

+The current edition of regulation for the electrical equipment issued by the institution of electrical engineers. +Kenya power and lighting Co. Ltd.

+ Instal water ring main with fire hydrant with 2.5" instantaneous coupling adaptors + Provide underground water tank with automatic electric booster pump for ring main + Provide automatic push button fire alarm system

+ Provide heat and smoke detectors in each room + Provide 9kg. dry powder fire extinguishers to ME specifications

Abbreviations	Meaning	
svp	soil vent pipe	
mh	man hole	
ic	inspection chamber	
rcc	reinforced cement conrete	
gt	gully trap	
ss sink	stain-less steel sink	
whb	wash hand basin	
wc	water closet	
shw	shower	
cc	centre to centre	
st. eng/S.E.	structural engineer	
dpc	damp proof course-under all grd. fl. wallings	
dpm	damp proof membrane	
gl	ground level	
pv	permanent ventilation-on all	

windows & doors except on internal

No	REVISIONS	DATE	SIGNATURE

toilet doors.

PROPOSED KENYA MARINE FISHERIES AND SOCIO-ECONOMIC DEVELOPMENT (KEMFSED)

Plot: PLOT L.R. NO. 209/15372,

PROJECT SOUTH C, NAIROBI.

STATE DEPARTMENT FOR FISHERIES AQUACULTURE AND THE BLUE ECONOMY

[working drawings]

Consultants:

ARPRIM CONSULTANTS **P. O. Box** 12969 - 00400

Tel: 020-884312/8 E-mail: www.arprimconsultants.com

Checked by: -B. Arch. (Hons), M. Arch.


MAAK (A)

Reg. Architect

(reg. No. A1552) **Date:** 14/06/2022 **Job No. :2021/Jan/UVUVI HOUSE**

B.Tech., Reg. Arch. MAAK (A) Architect (reg. No. A1122)

Scale: 1:100 unless shown

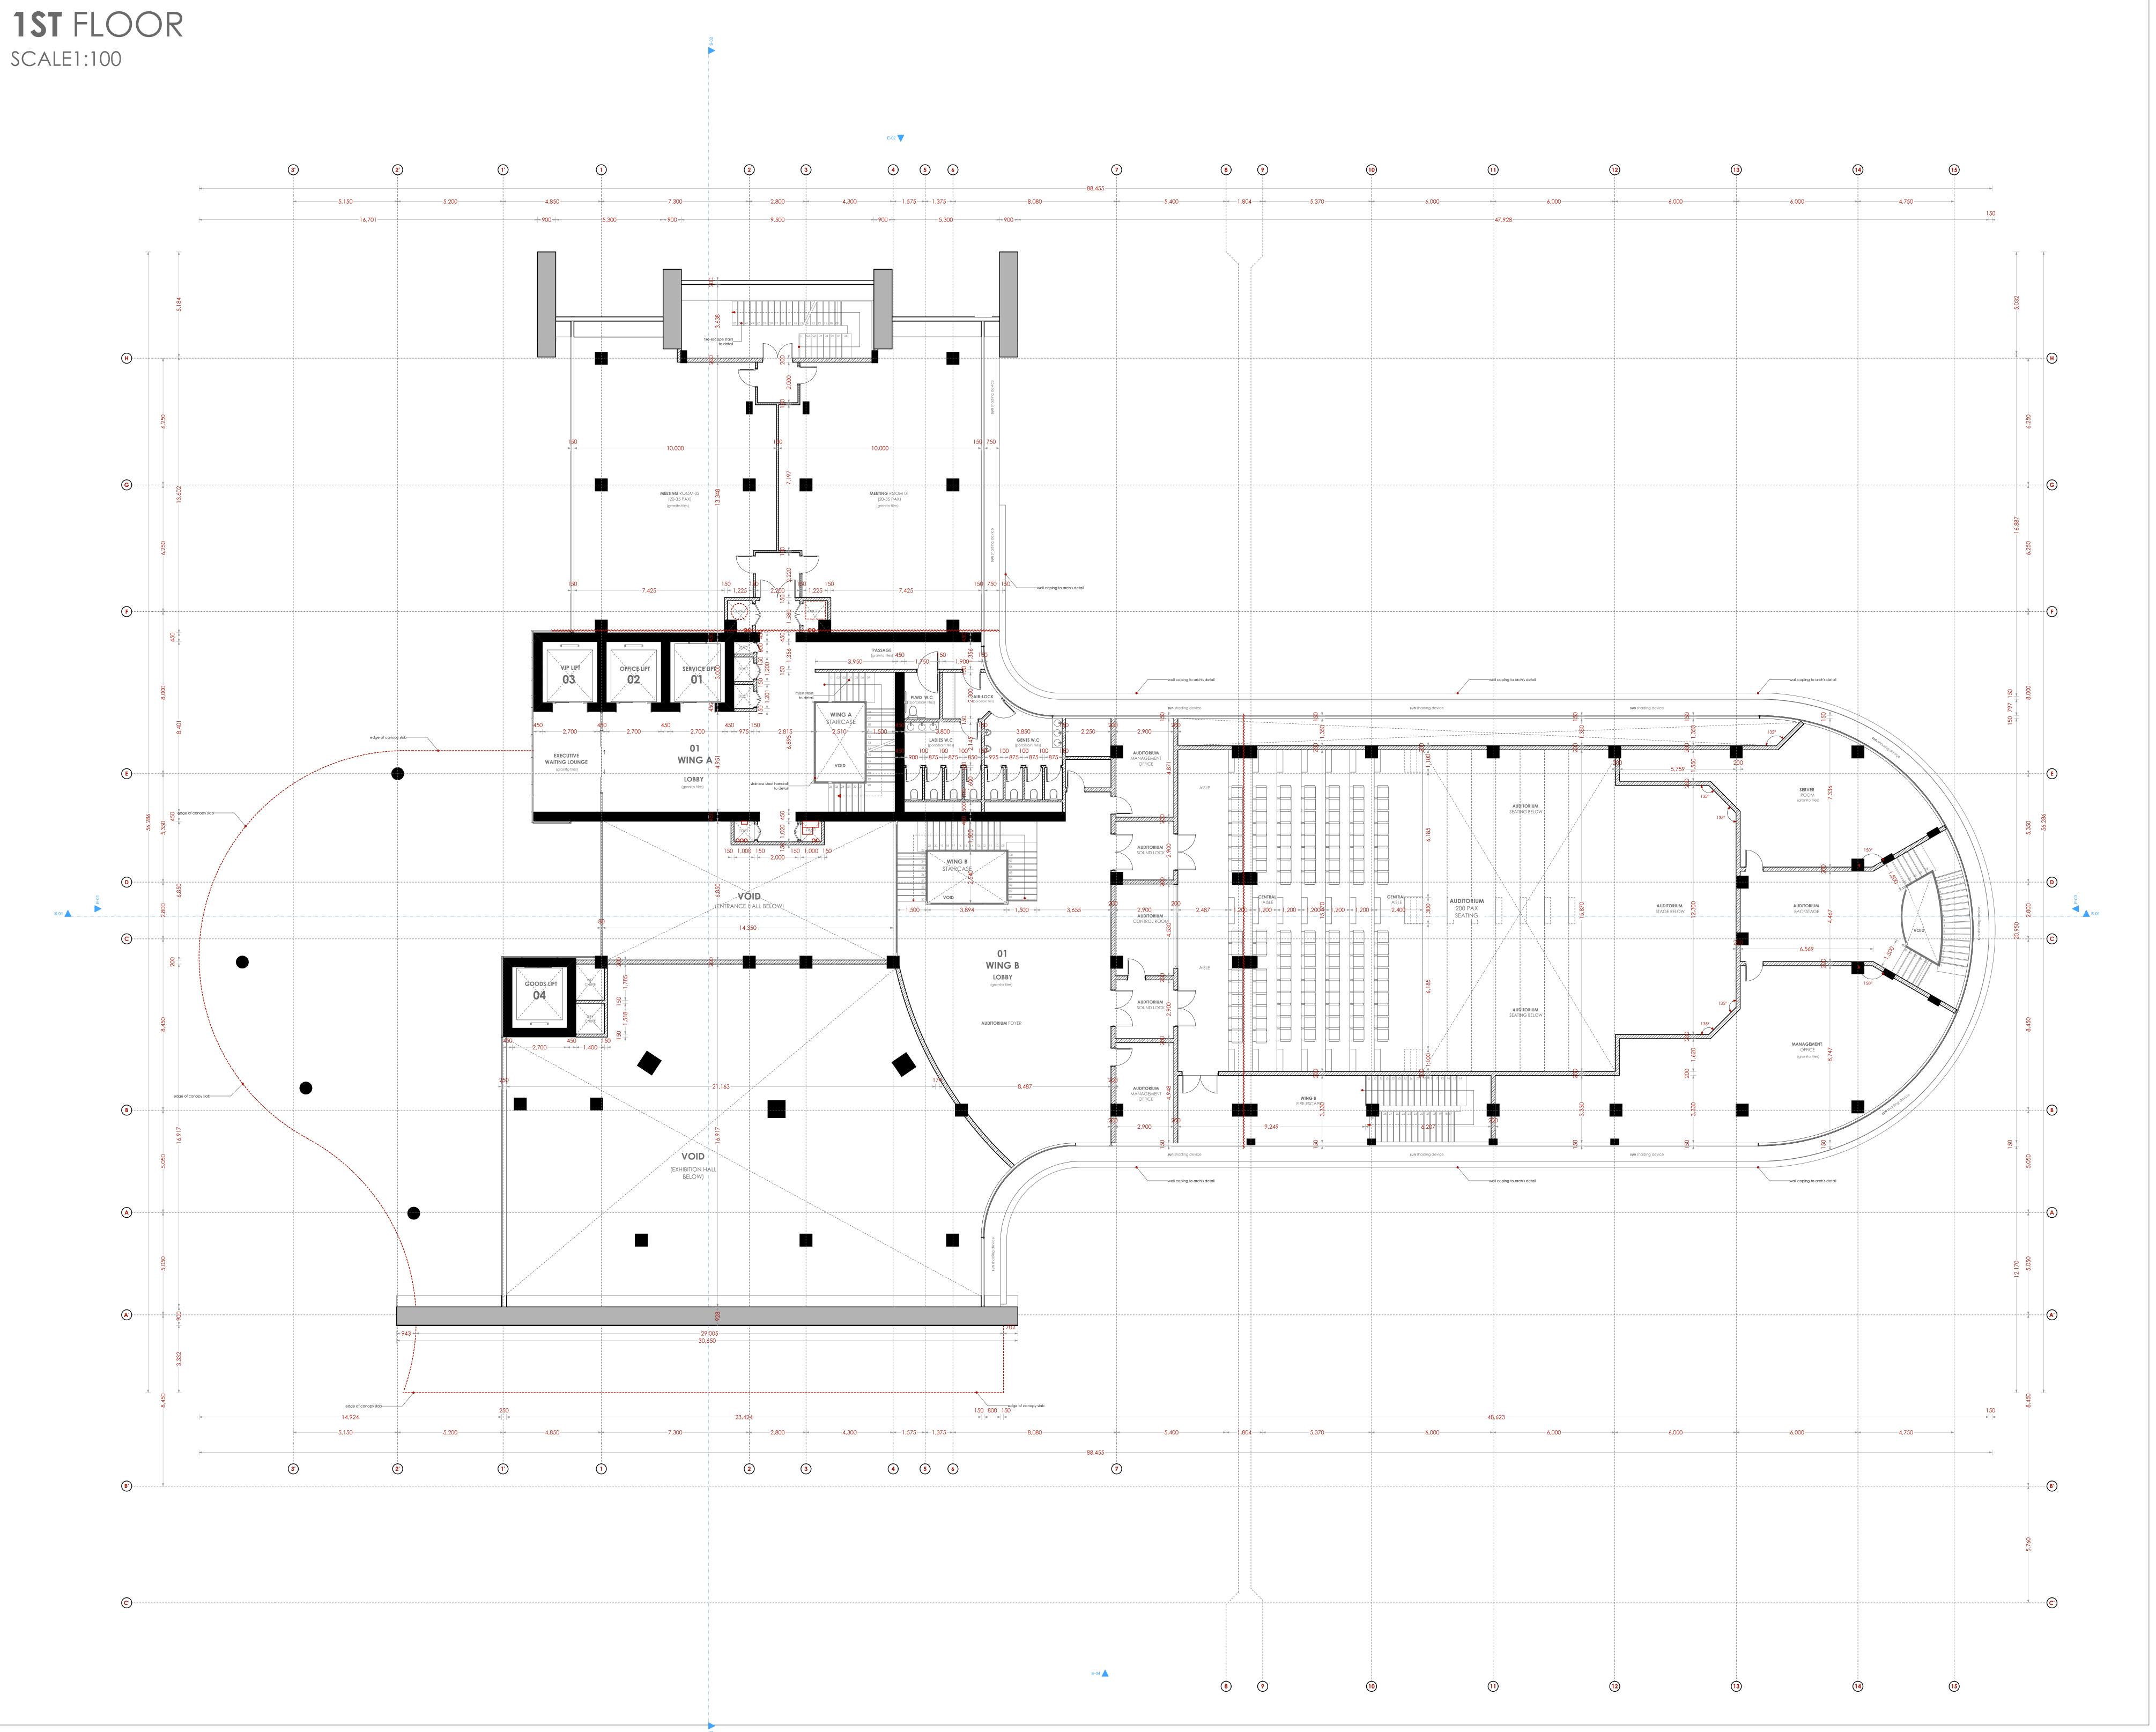

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on compacted hardcore.

commencement of any work.

<u>CONSTRUCTION</u>
+ Damp proof course must be provided under all external walls at grade. DPC to be minimum 150mm above ground level. + All slab at grade to be poured on 1000gauge polytheneon 50mm stone dust blinding

+ All soils under slab and around external foundation to be treated for termite control.

CIVIL WORKS +All soil under slabs and all around external foundations to be

treated with anti- termite pesticide AND should be executed bylicensed and duly registered sub contractor. +Sample for pipe works and other materials for road works specified to be presented to the engineer before works commences. +All levels for sewer and road works must be approved by the engineer before work commences.

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Meaning Abbreviations soil vent pipe man hole inspection chamber reinforced cement conrete gully trap stain-less steel sink wash hand basin water closet shower centre to centre st. eng/S.E. structural engineer

damp proof course-under

damp proof membrane

permanent ventilation-on all

windows & doors except on internal

all grd. fl. wallings

ground level

toilet doors.

No	REVISIONS	DATE	SIGNATURE

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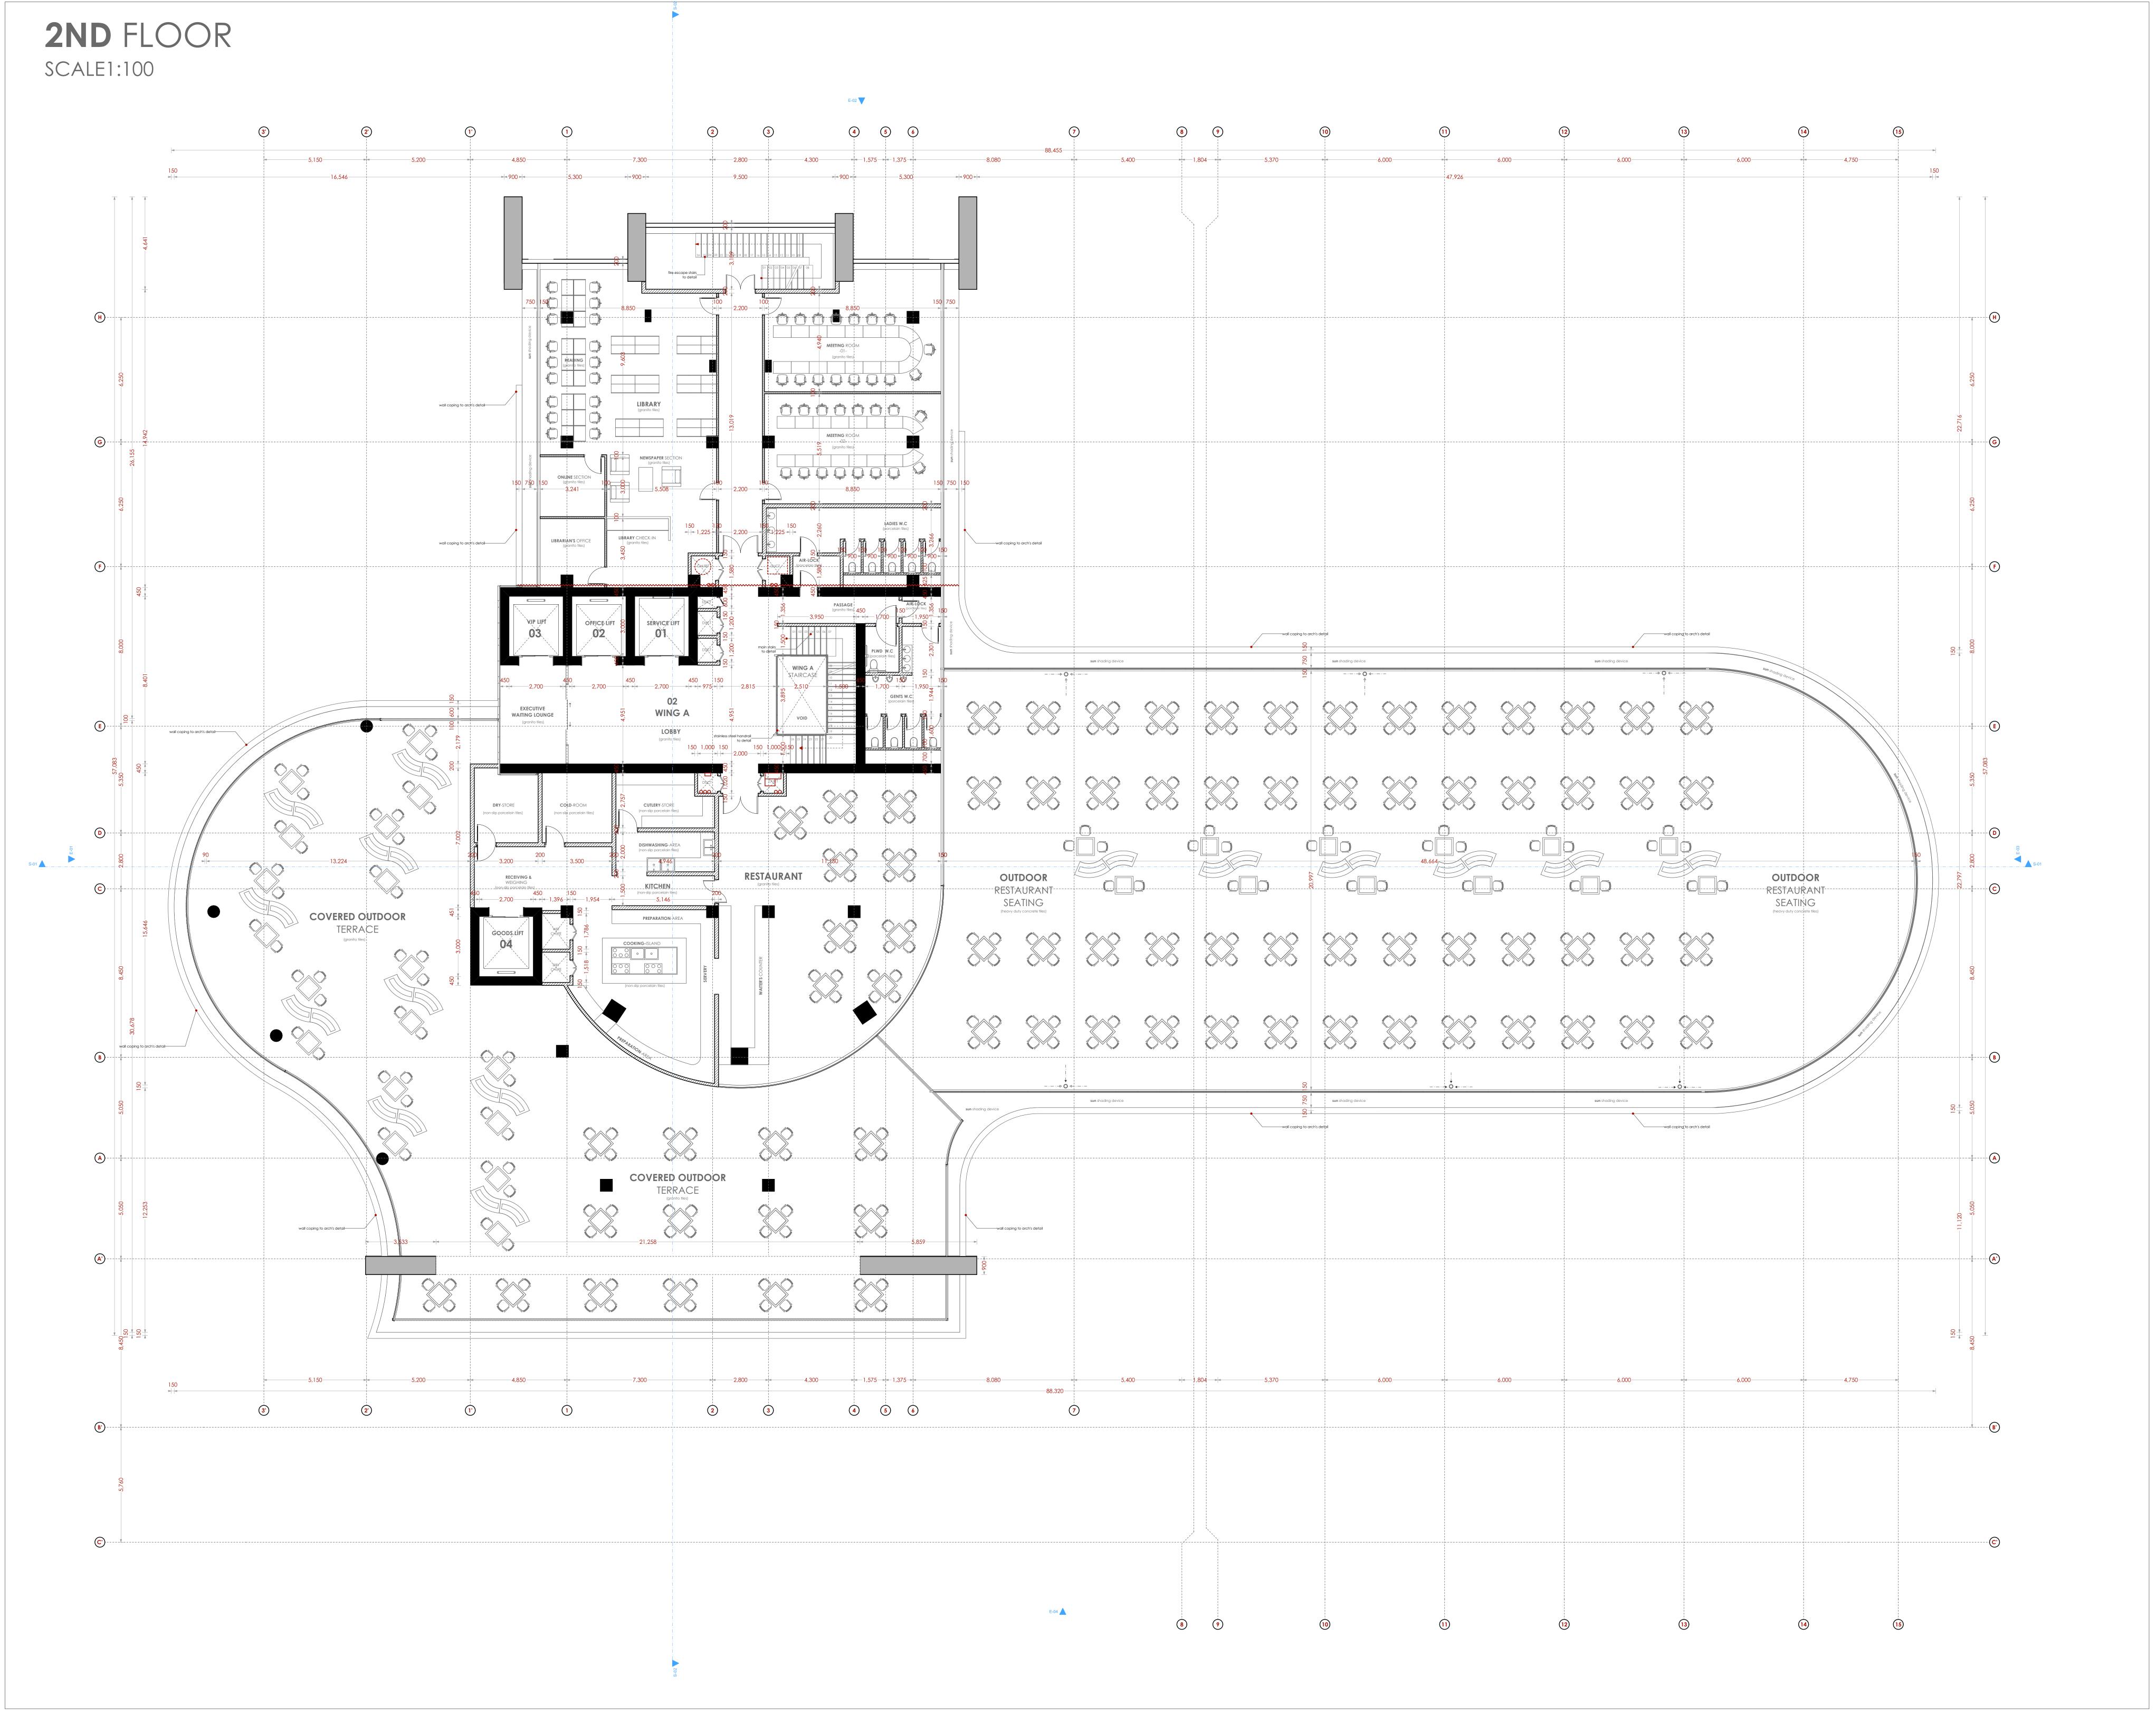
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+Depth of the foundation to be determined on site to S.E's approval.

+All timber to be sawn cypress G.S grade to KS 02-771:1989 and seasoned to equilibrium moisture content between 9% and 15%.

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windows & doors except on internal

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Plot: PLOT L.R. NO. 209/15372,

PROJECT SOUTH C, NAIROBI.

STATE DEPARTMENT FOR FISHERIES AQUACULTURE AND THE BLUE ECONOMY

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MAAK (A)

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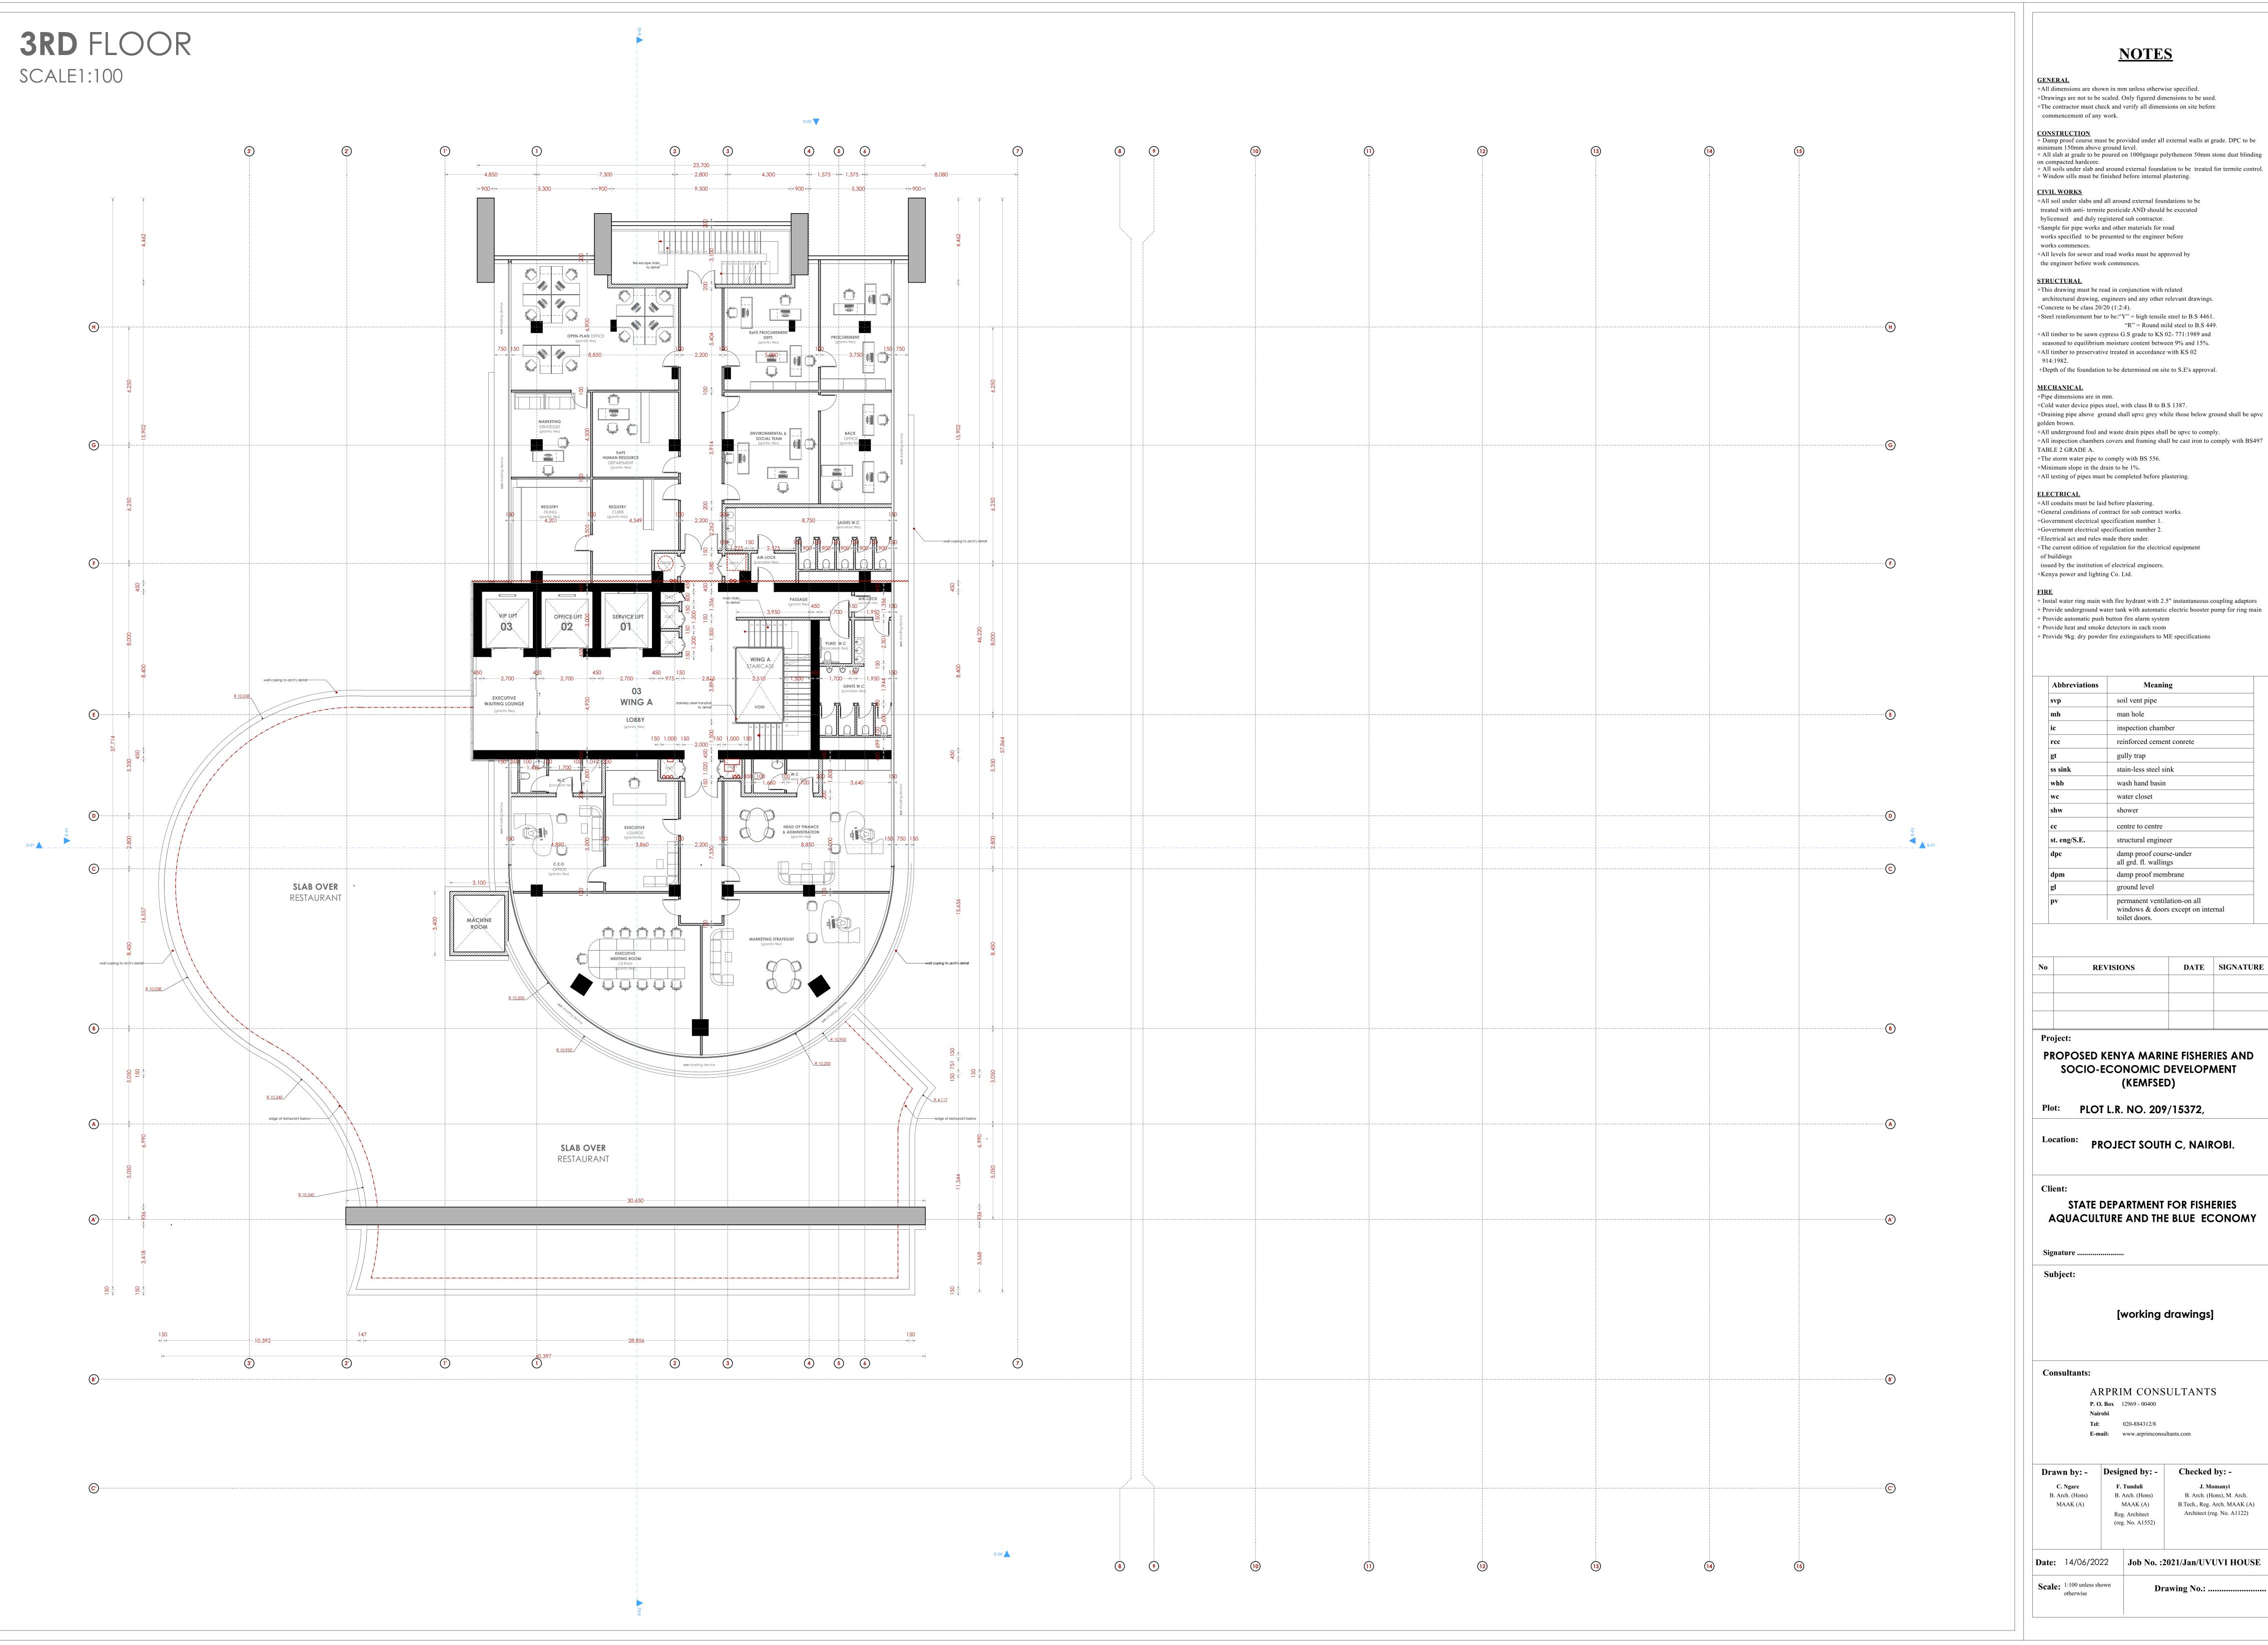
Designed by: -Checked by:

Architect (reg. No. A1122) Reg. Architect (reg. No. A1552) **Date:** 14/06/2022 Job No. :2021/Jan/UVUVI HOUSE

B. Arch. (Hons), M. Arch.

B.Tech., Reg. Arch. MAAK (A)

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Appreviations	Wieaning
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No	REVISIONS	DATE	SIGNATURE

permanent ventilation-on all

windows & doors except on internal

PROPOSED KENYA MARINE FISHERIES AND SOCIO-ECONOMIC DEVELOPMENT (KEMFSED)

ground level

toilet doors.

Plot: PLOT L.R. NO. 209/15372,

PROJECT SOUTH C, NAIROBI.

STATE DEPARTMENT FOR FISHERIES AQUACULTURE AND THE BLUE ECONOMY

[working drawings]

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MAAK (A)


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TABLE 2 GRADE A. +The storm water pipe to comply with BS 556.

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ELECTRICAL

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Abbreviations	Meaning
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No	REVISIONS	DATE	SIGNATURE

toilet doors.

windows & doors except on internal

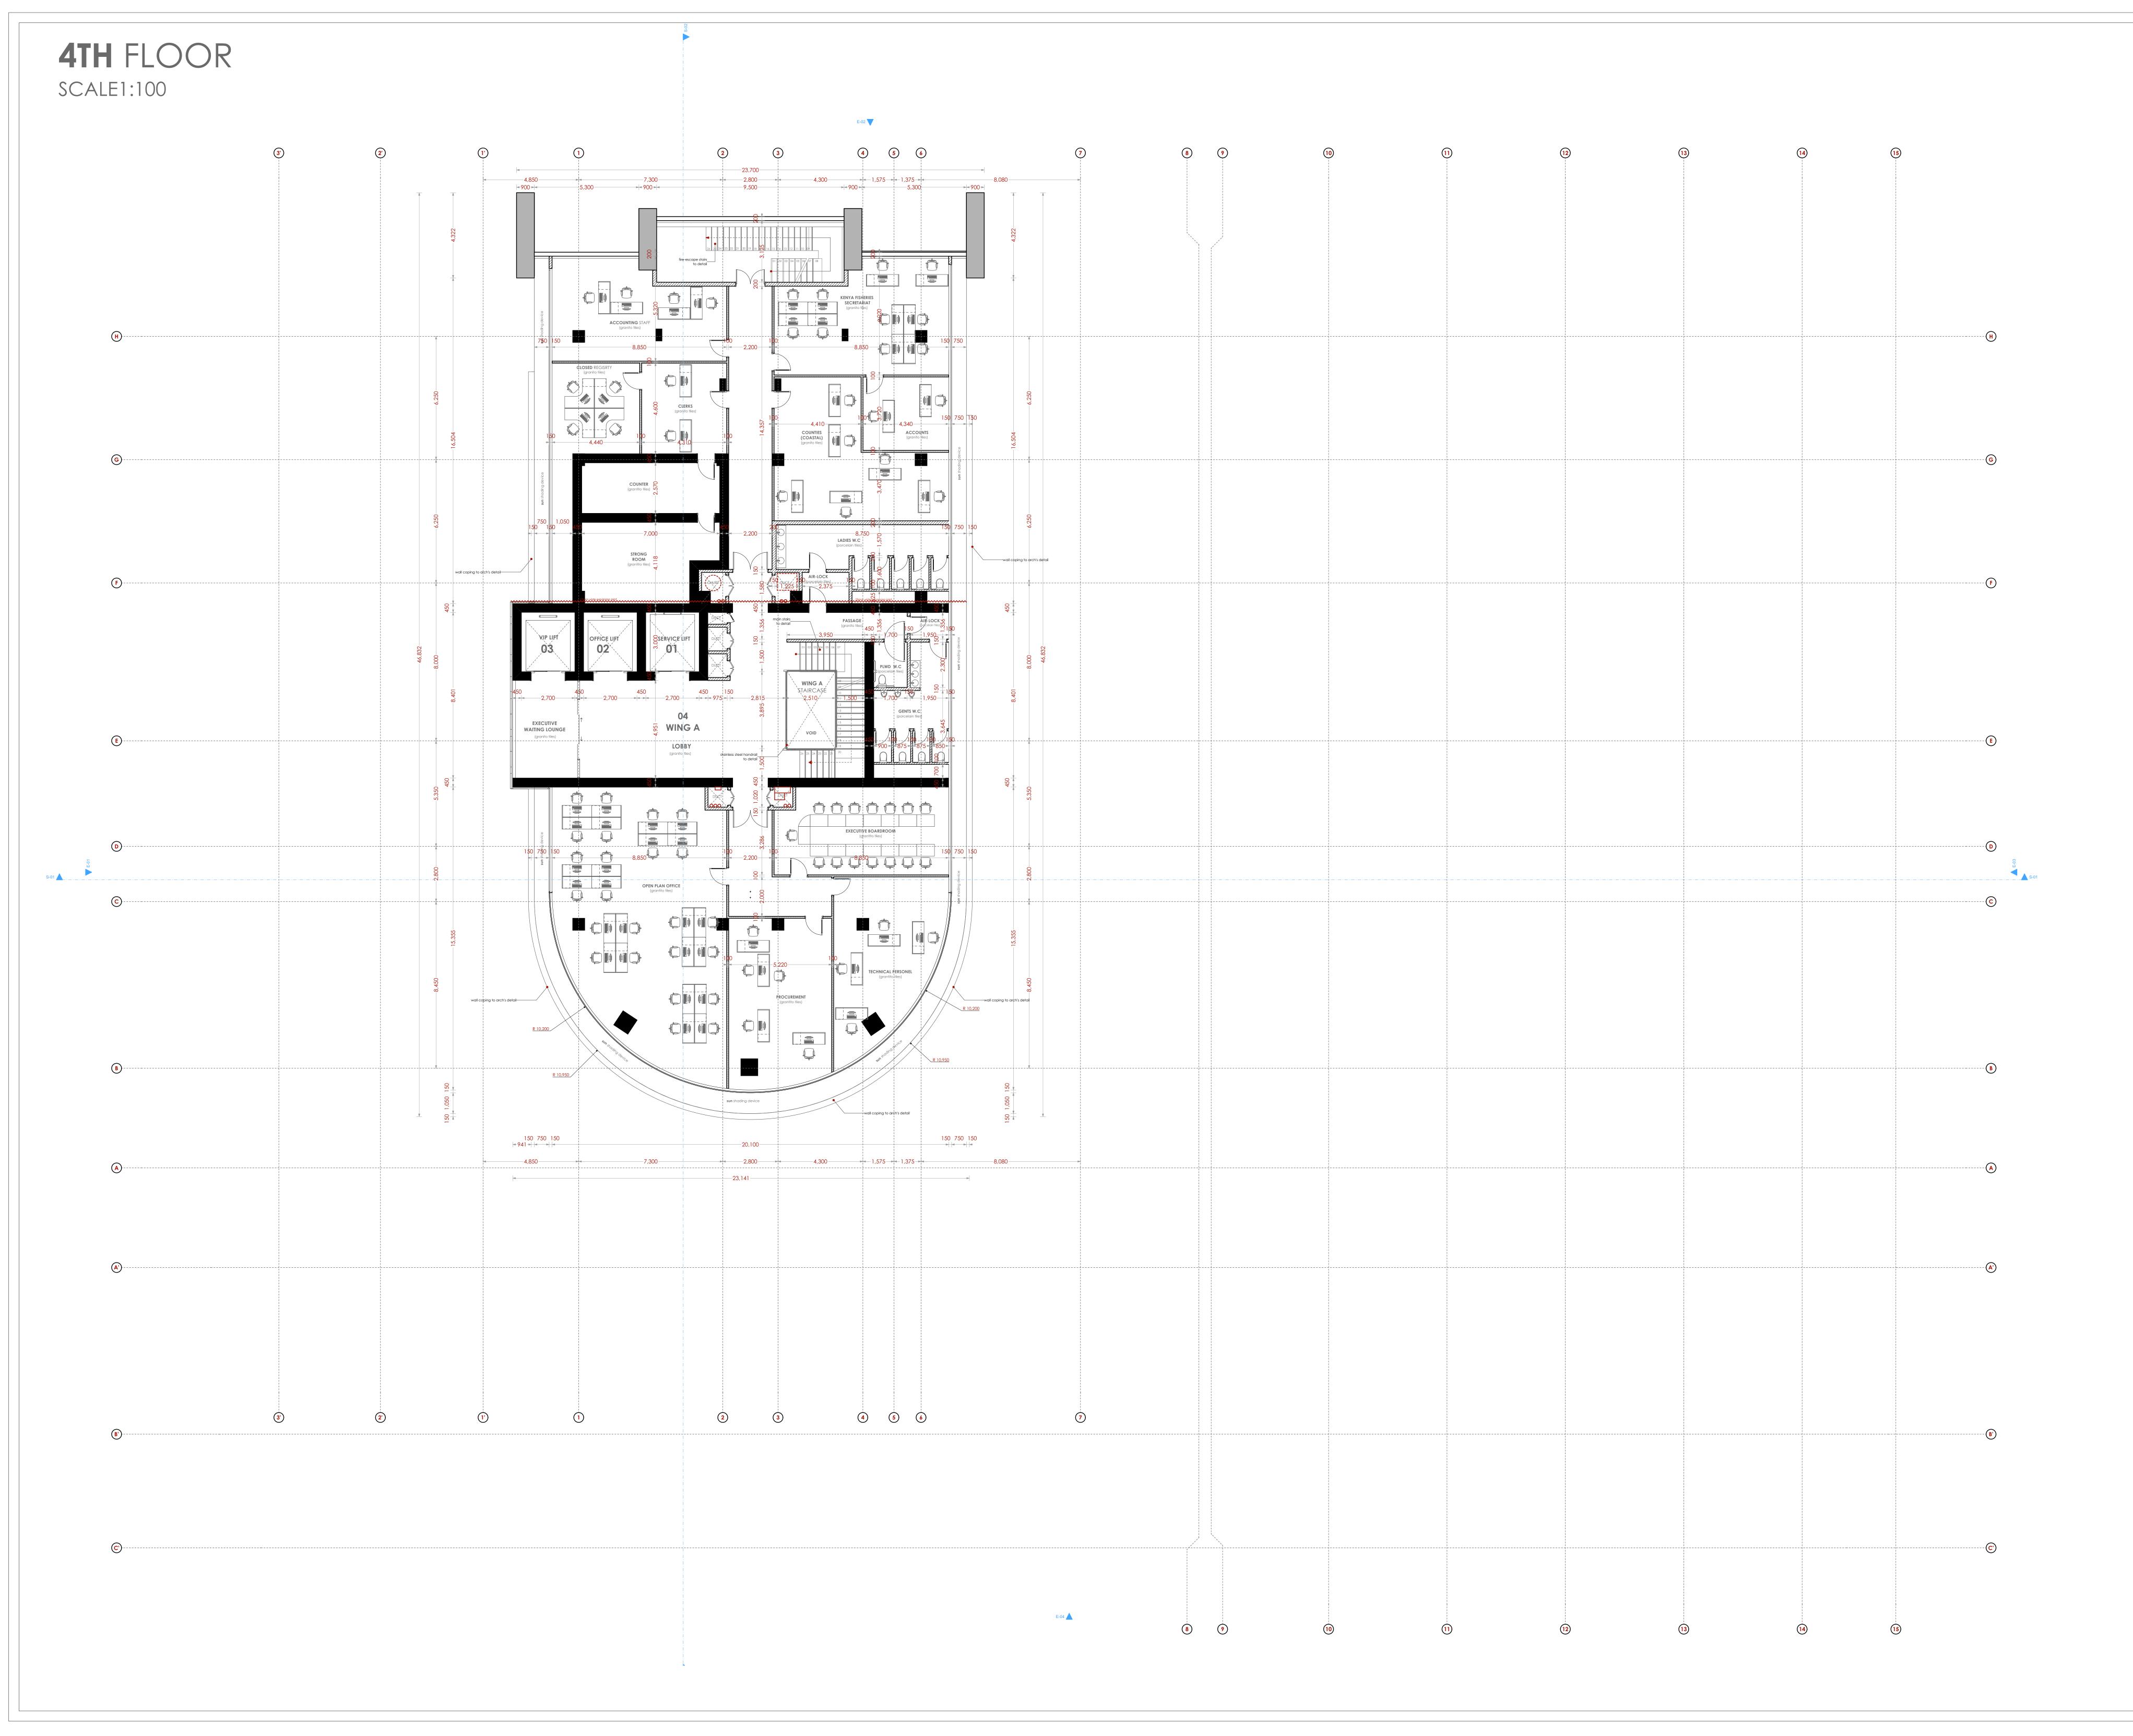PROPOSED KENYA MARINE FISHERIES AND SOCIO-ECONOMIC DEVELOPMENT (KEMFSED)

Plot: PLOT L.R. NO. 209/15372,

PROJECT SOUTH C, NAIROBI.

STATE DEPARTMENT FOR FISHERIES AQUACULTURE AND THE BLUE ECONOMY

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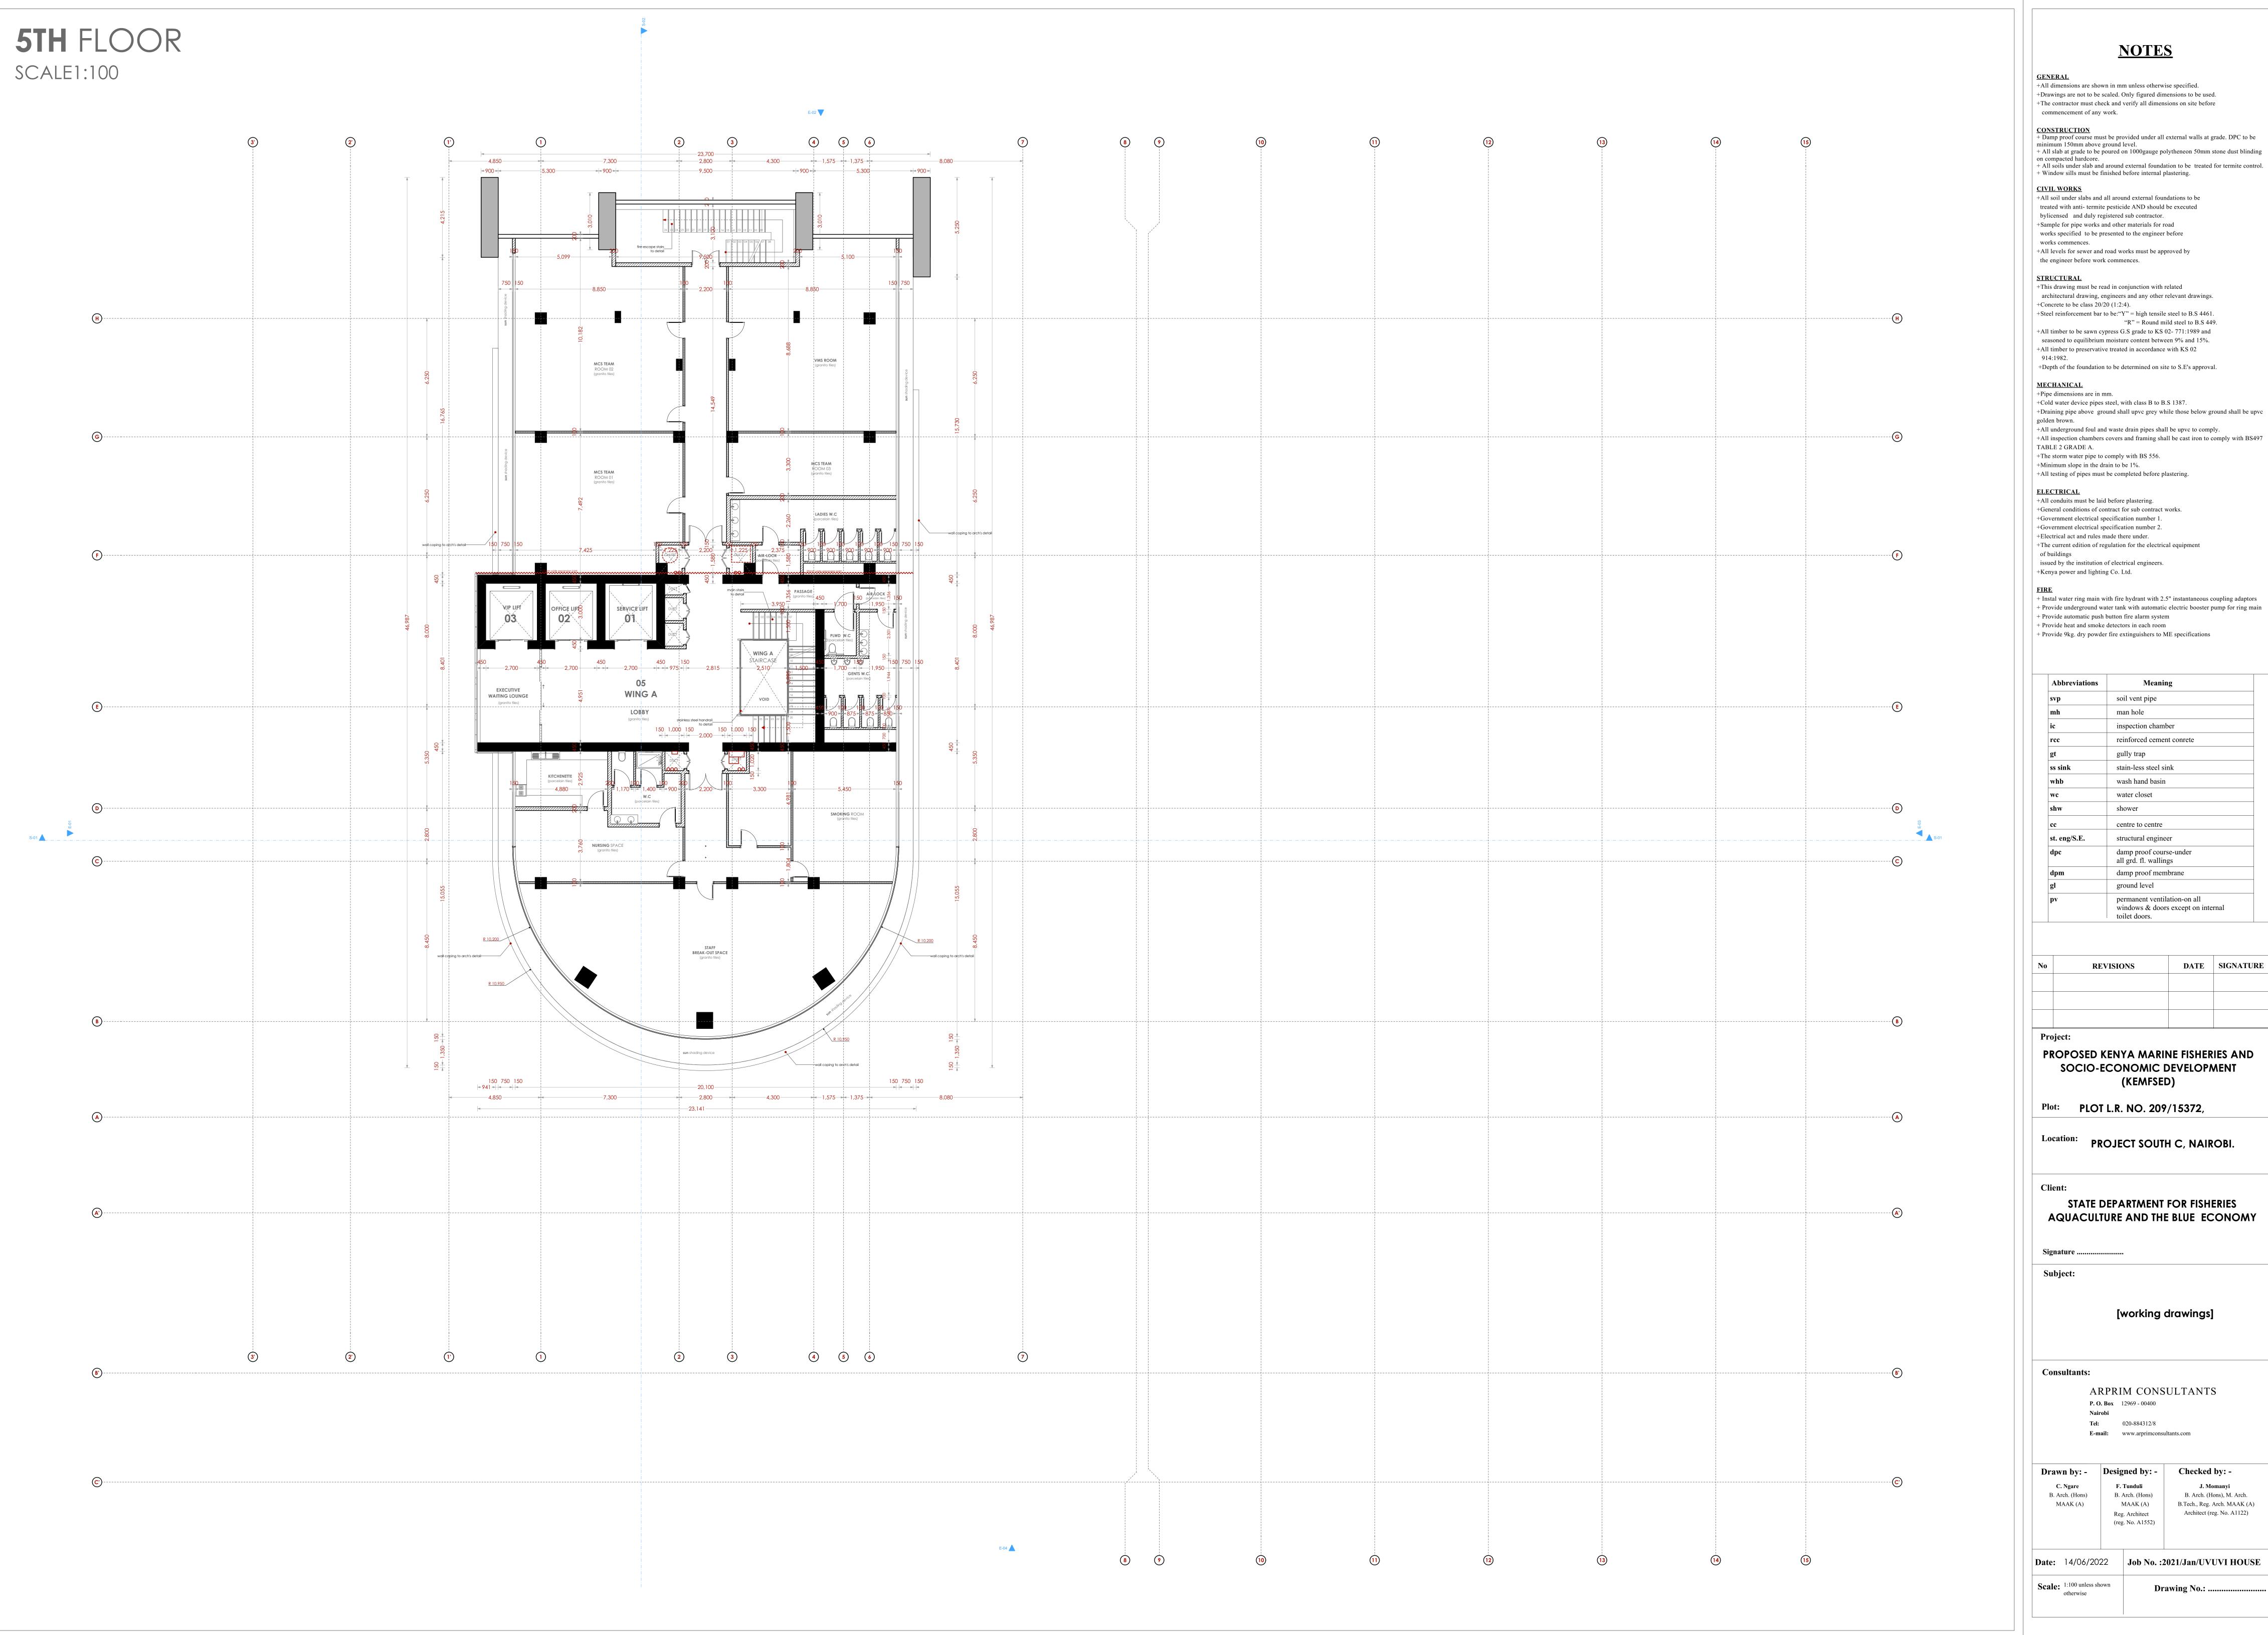
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> MAAK (A) B.Tech., Reg. Arch. MAAK (A) Architect (reg. No. A1122) Reg. Architect (reg. No. A1552)

Scale: 1:100 unless shown Drawing No.:

Date: 14/06/2022 **Job No. :2021/Jan/UVUVI HOUSE**



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PROPOSED KENYA MARINE FISHERIES AND SOCIO-ECONOMIC DEVELOPMENT (KEMFSED)

toilet doors.

Plot: PLOT L.R. NO. 209/15372,

PROJECT SOUTH C, NAIROBI.

STATE DEPARTMENT FOR FISHERIES AQUACULTURE AND THE BLUE ECONOMY

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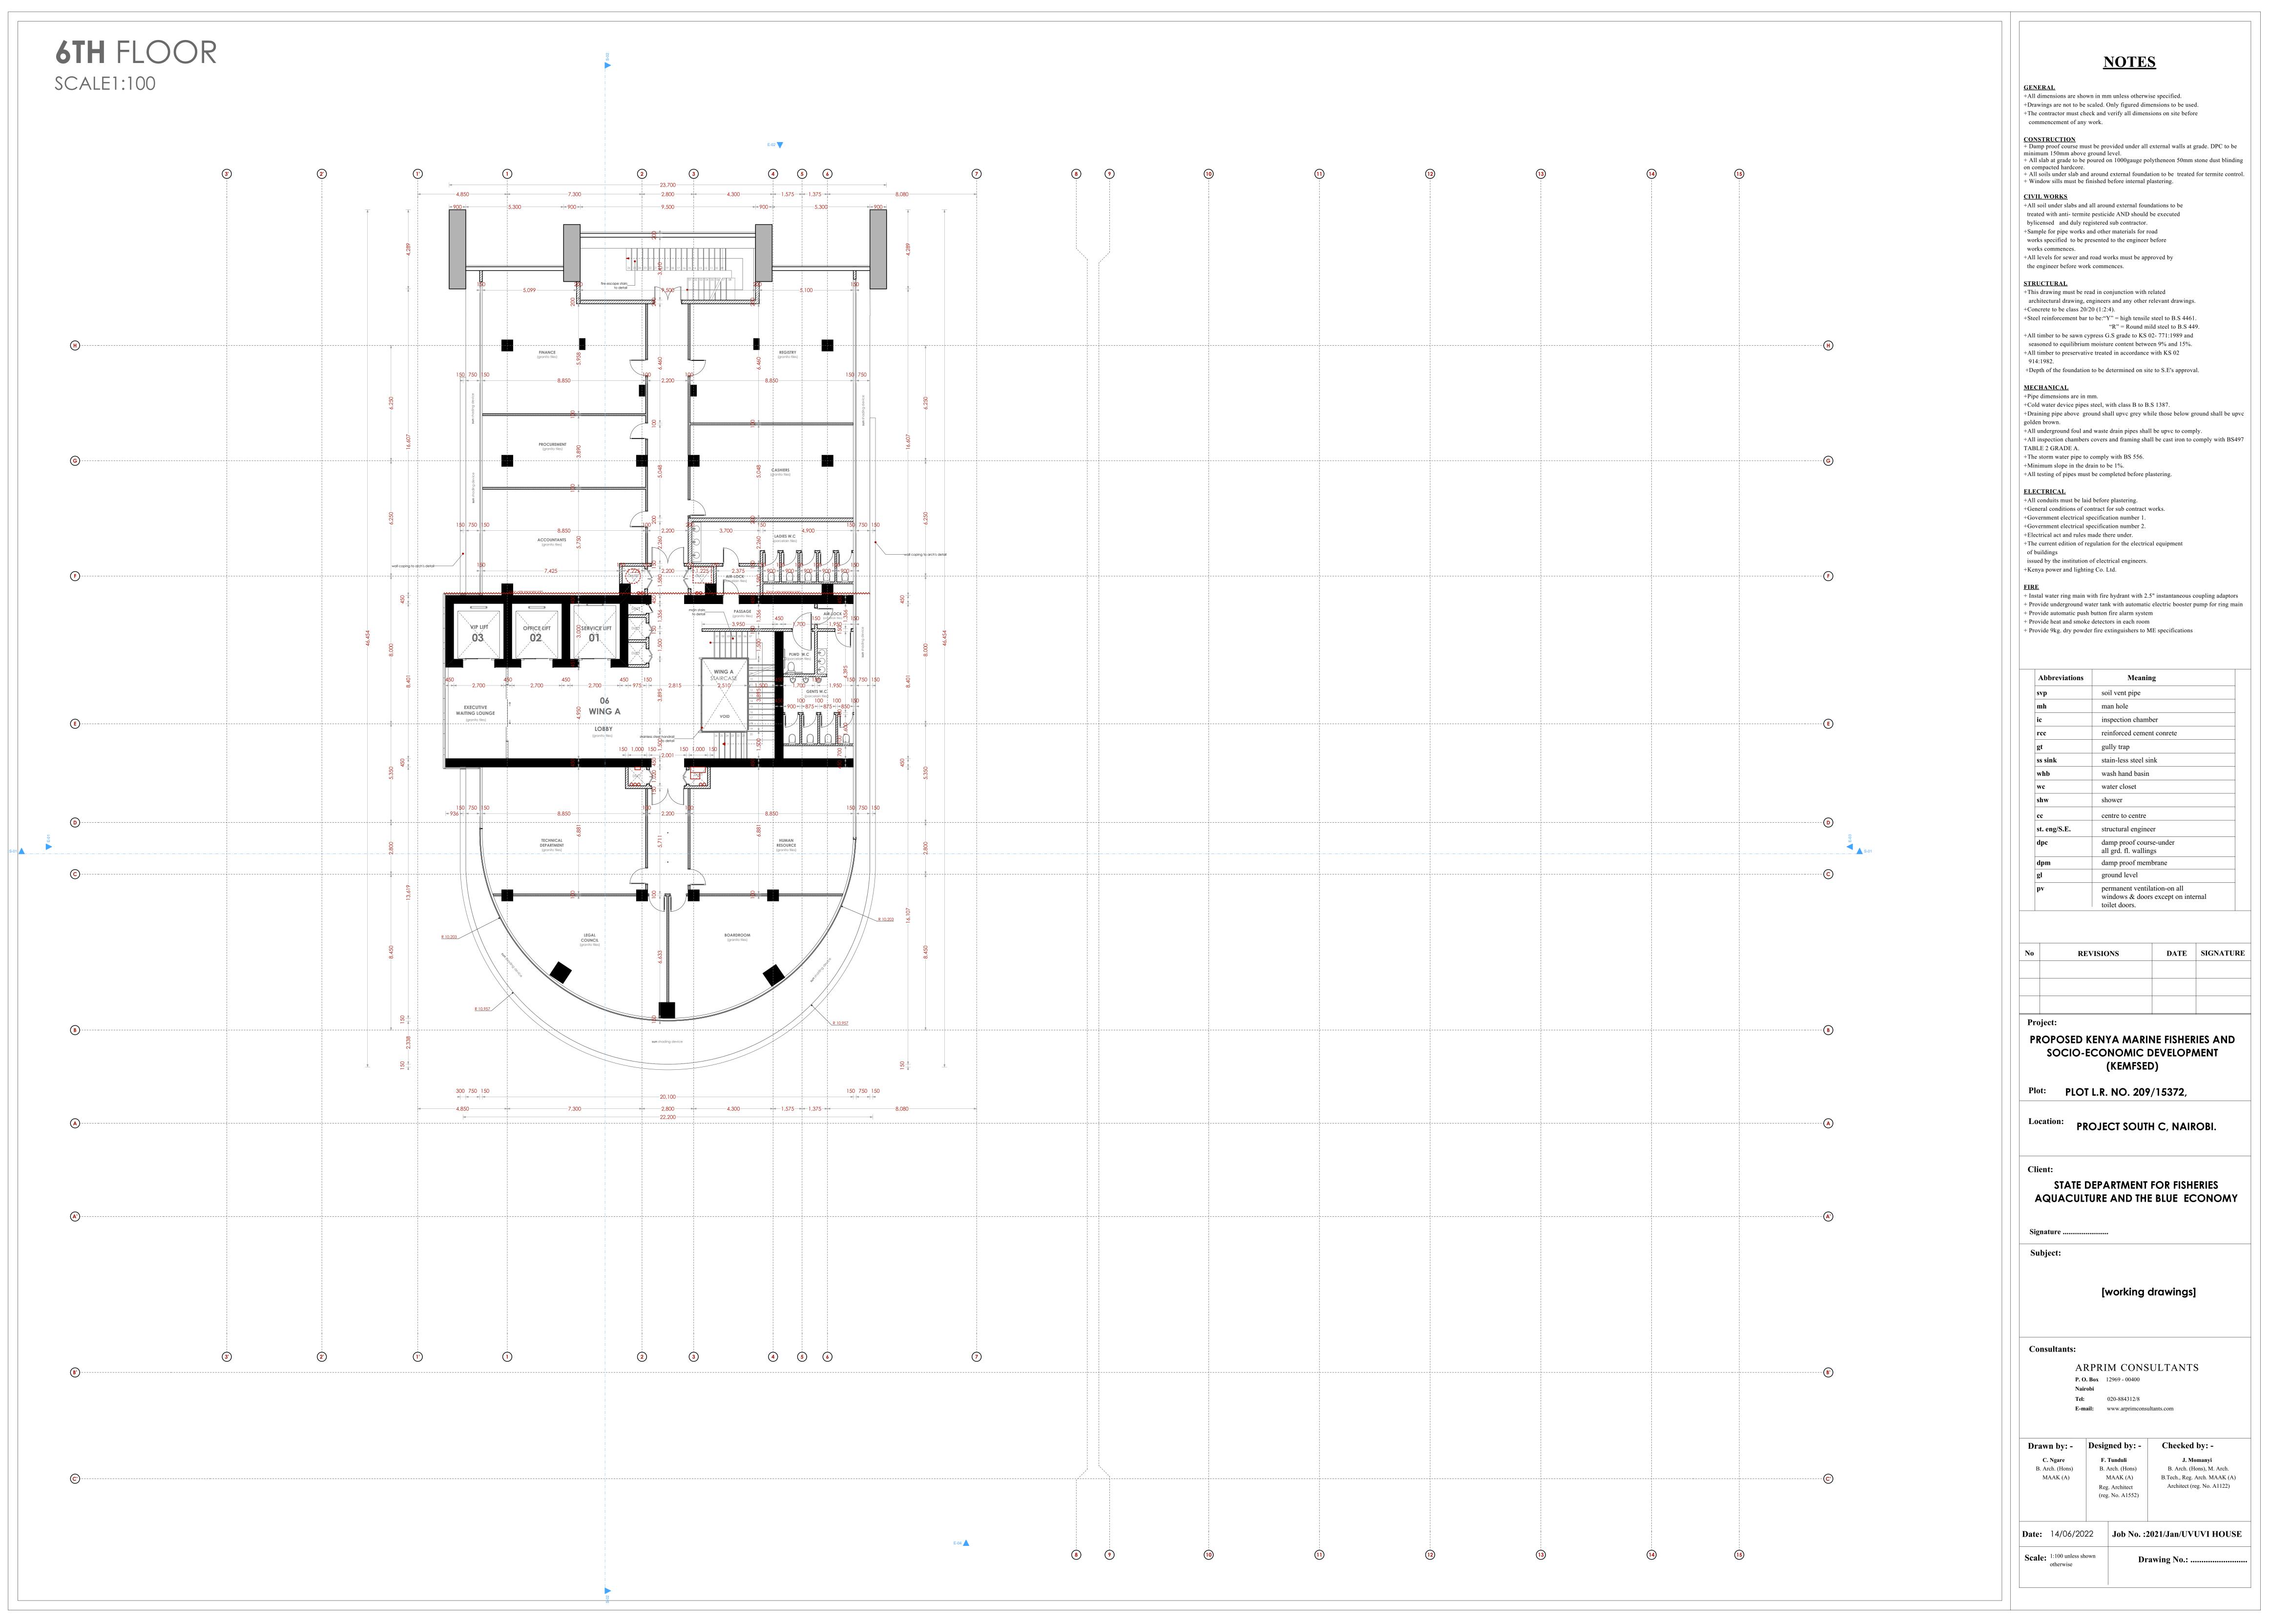
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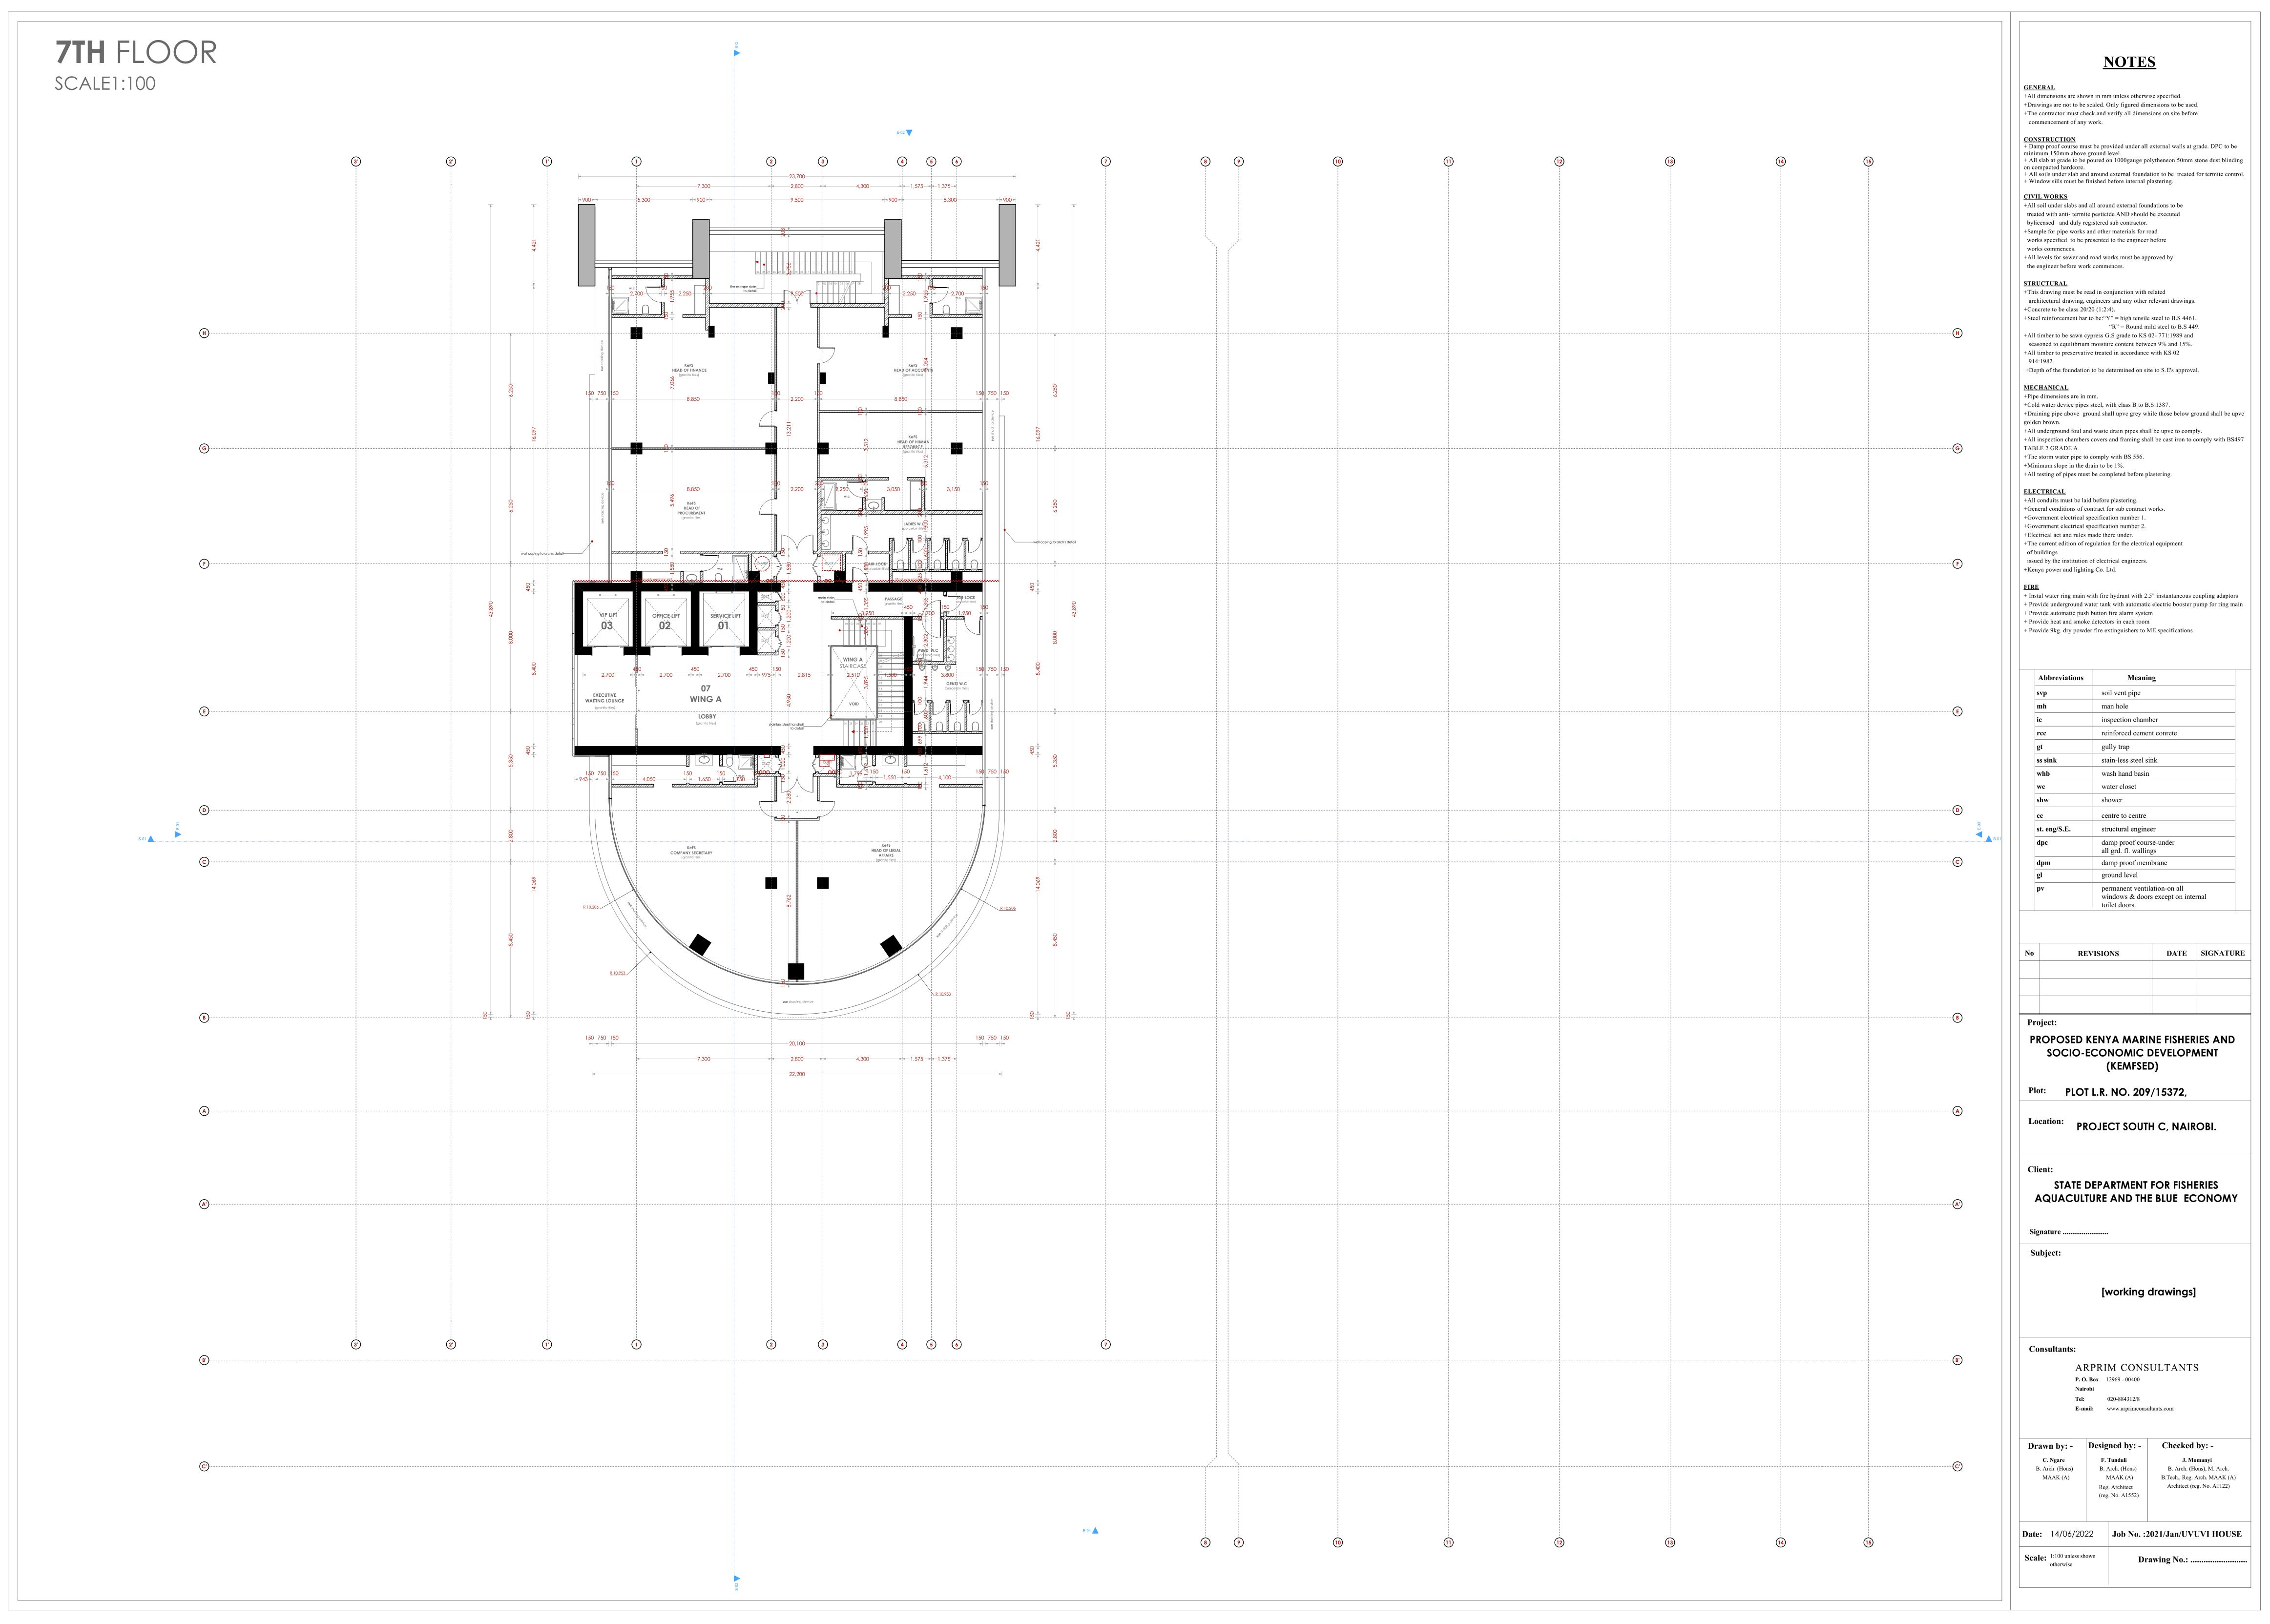
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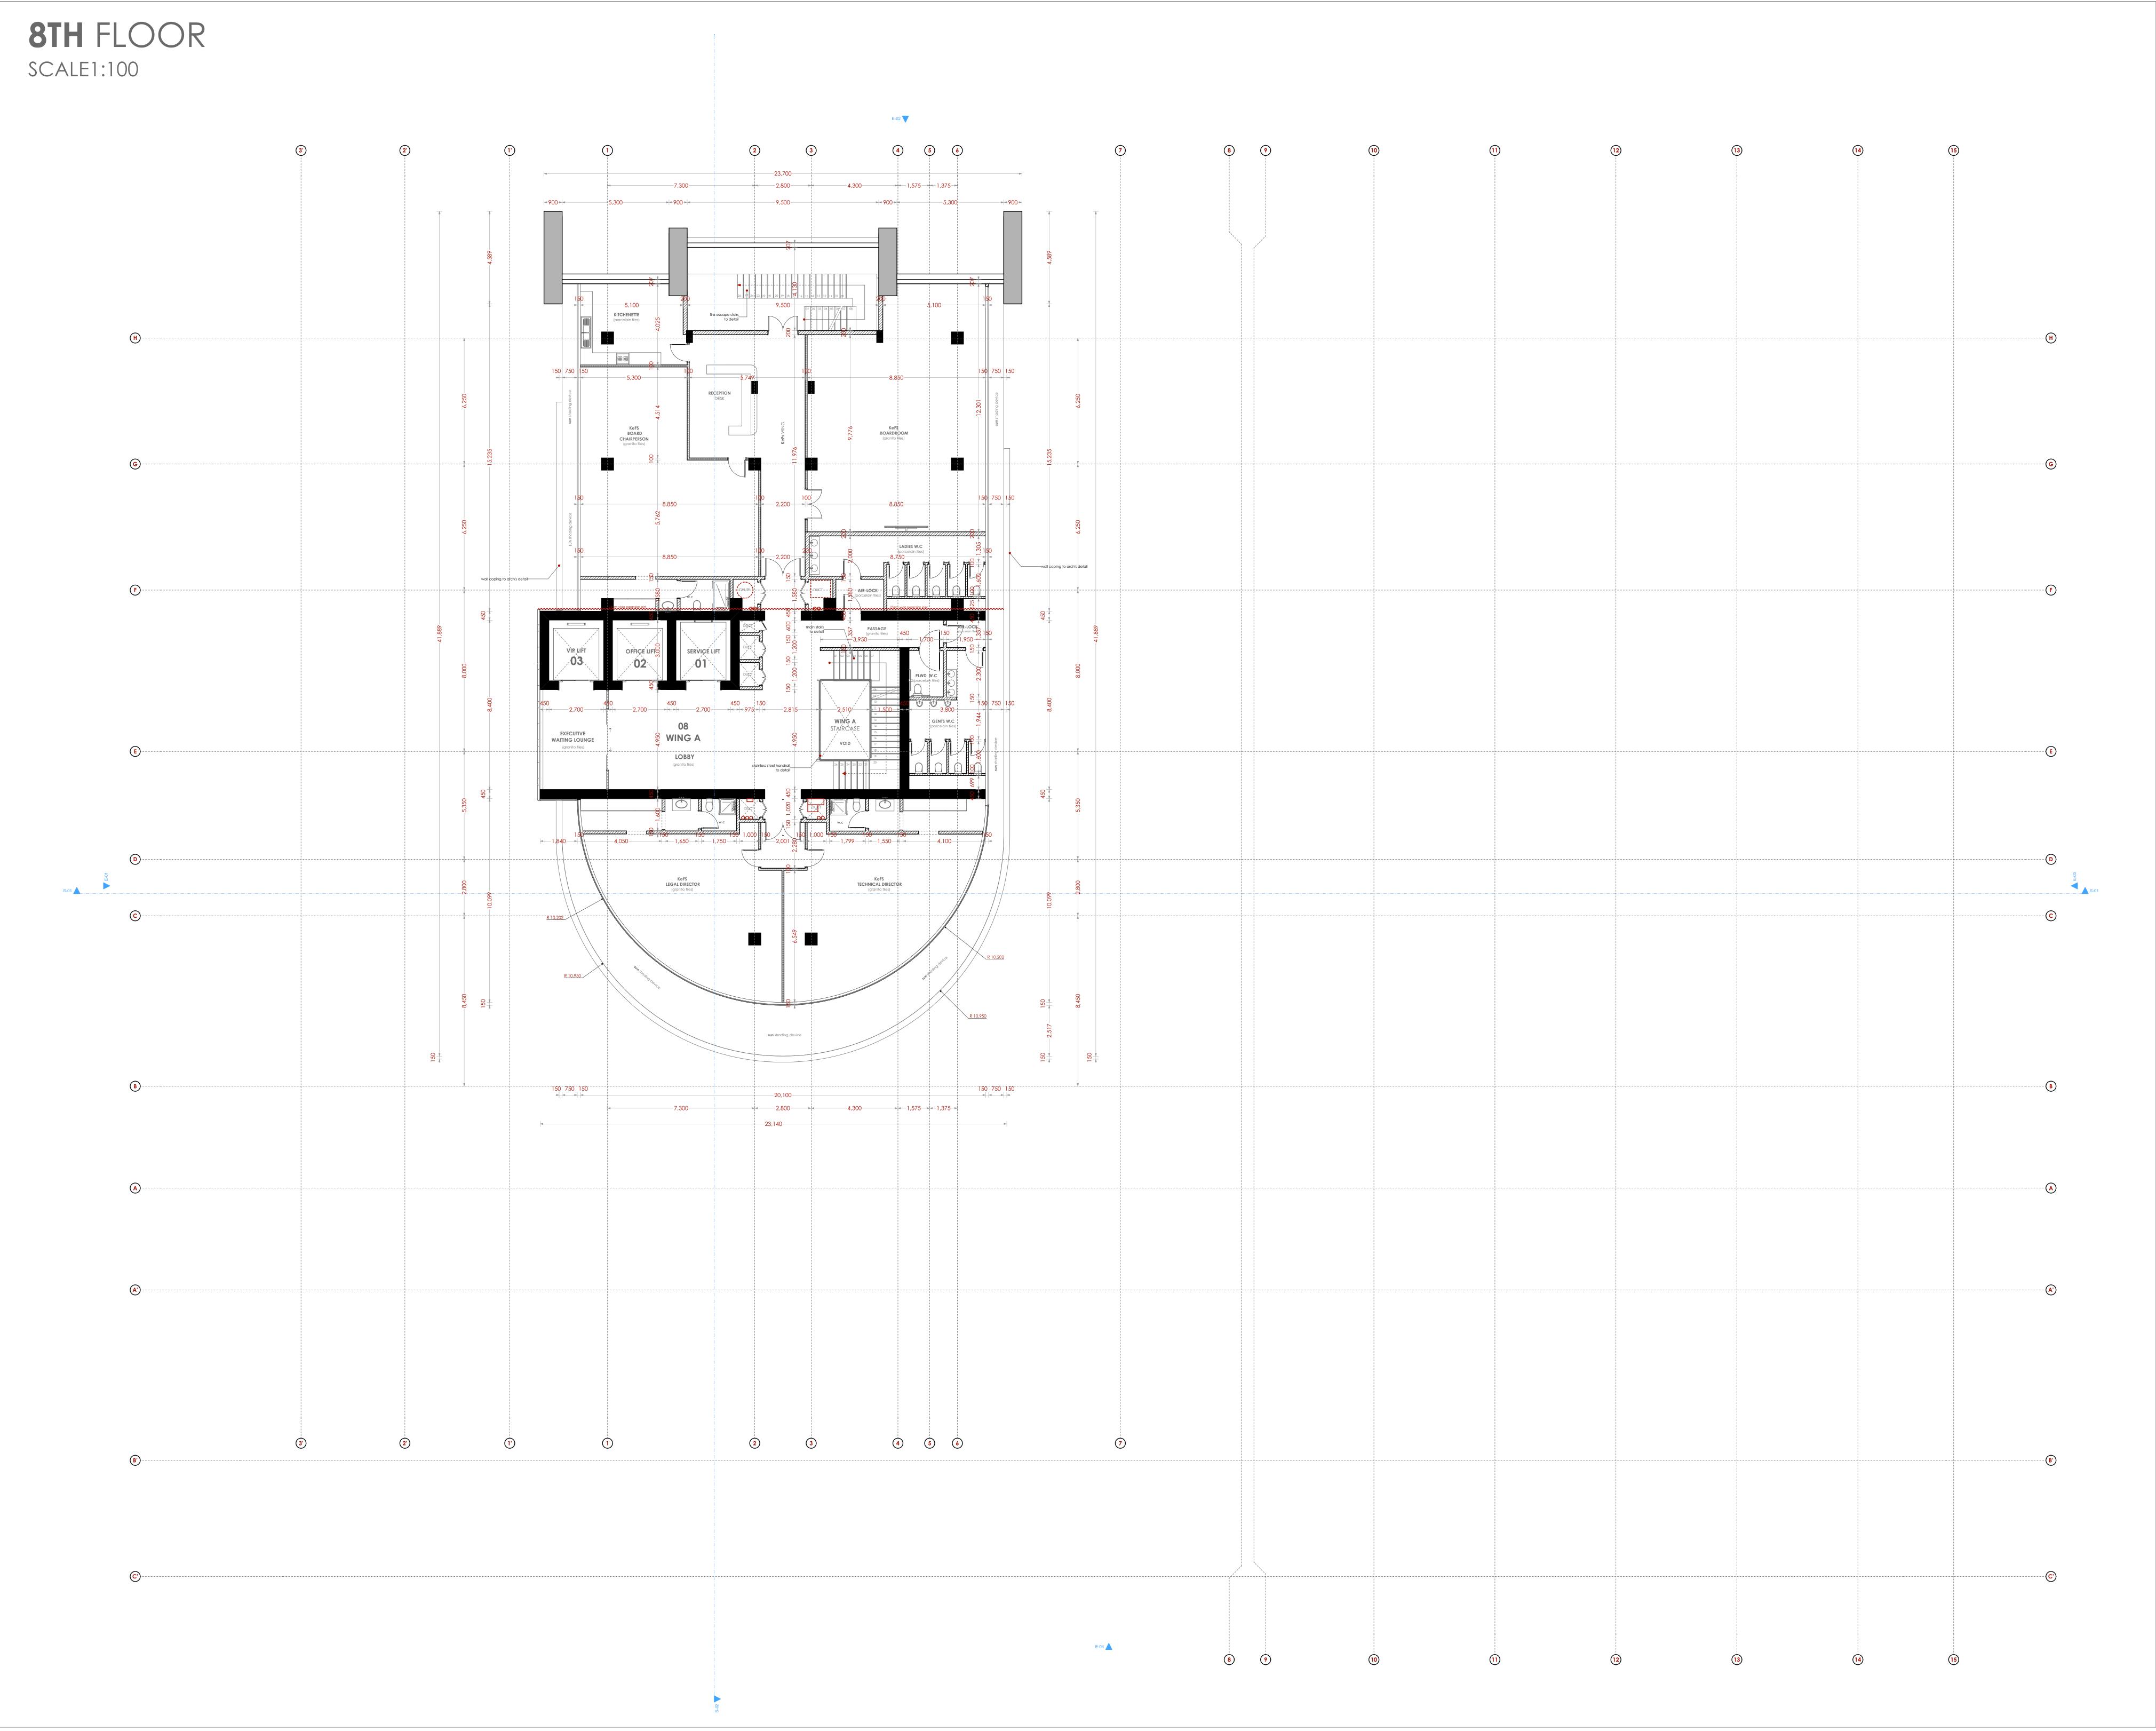
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Drawn by: - Designed by: -


Architect (reg. No. A1122) (reg. No. A1552) **Date:** 14/06/2022 **Job No. :2021/Jan/UVUVI HOUSE**

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+Pipe dimensions are in mm. +Cold water device pipes steel, with class B to B.S 1387.

+Draining pipe above ground shall upvc grey while those below ground shall be upvc golden brown. +All underground foul and waste drain pipes shall be upvc to comply.

+All inspection chambers covers and framing shall be cast iron to comply with BS497 TABLE 2 GRADE A.

+The storm water pipe to comply with BS 556. +Minimum slope in the drain to be 1%.

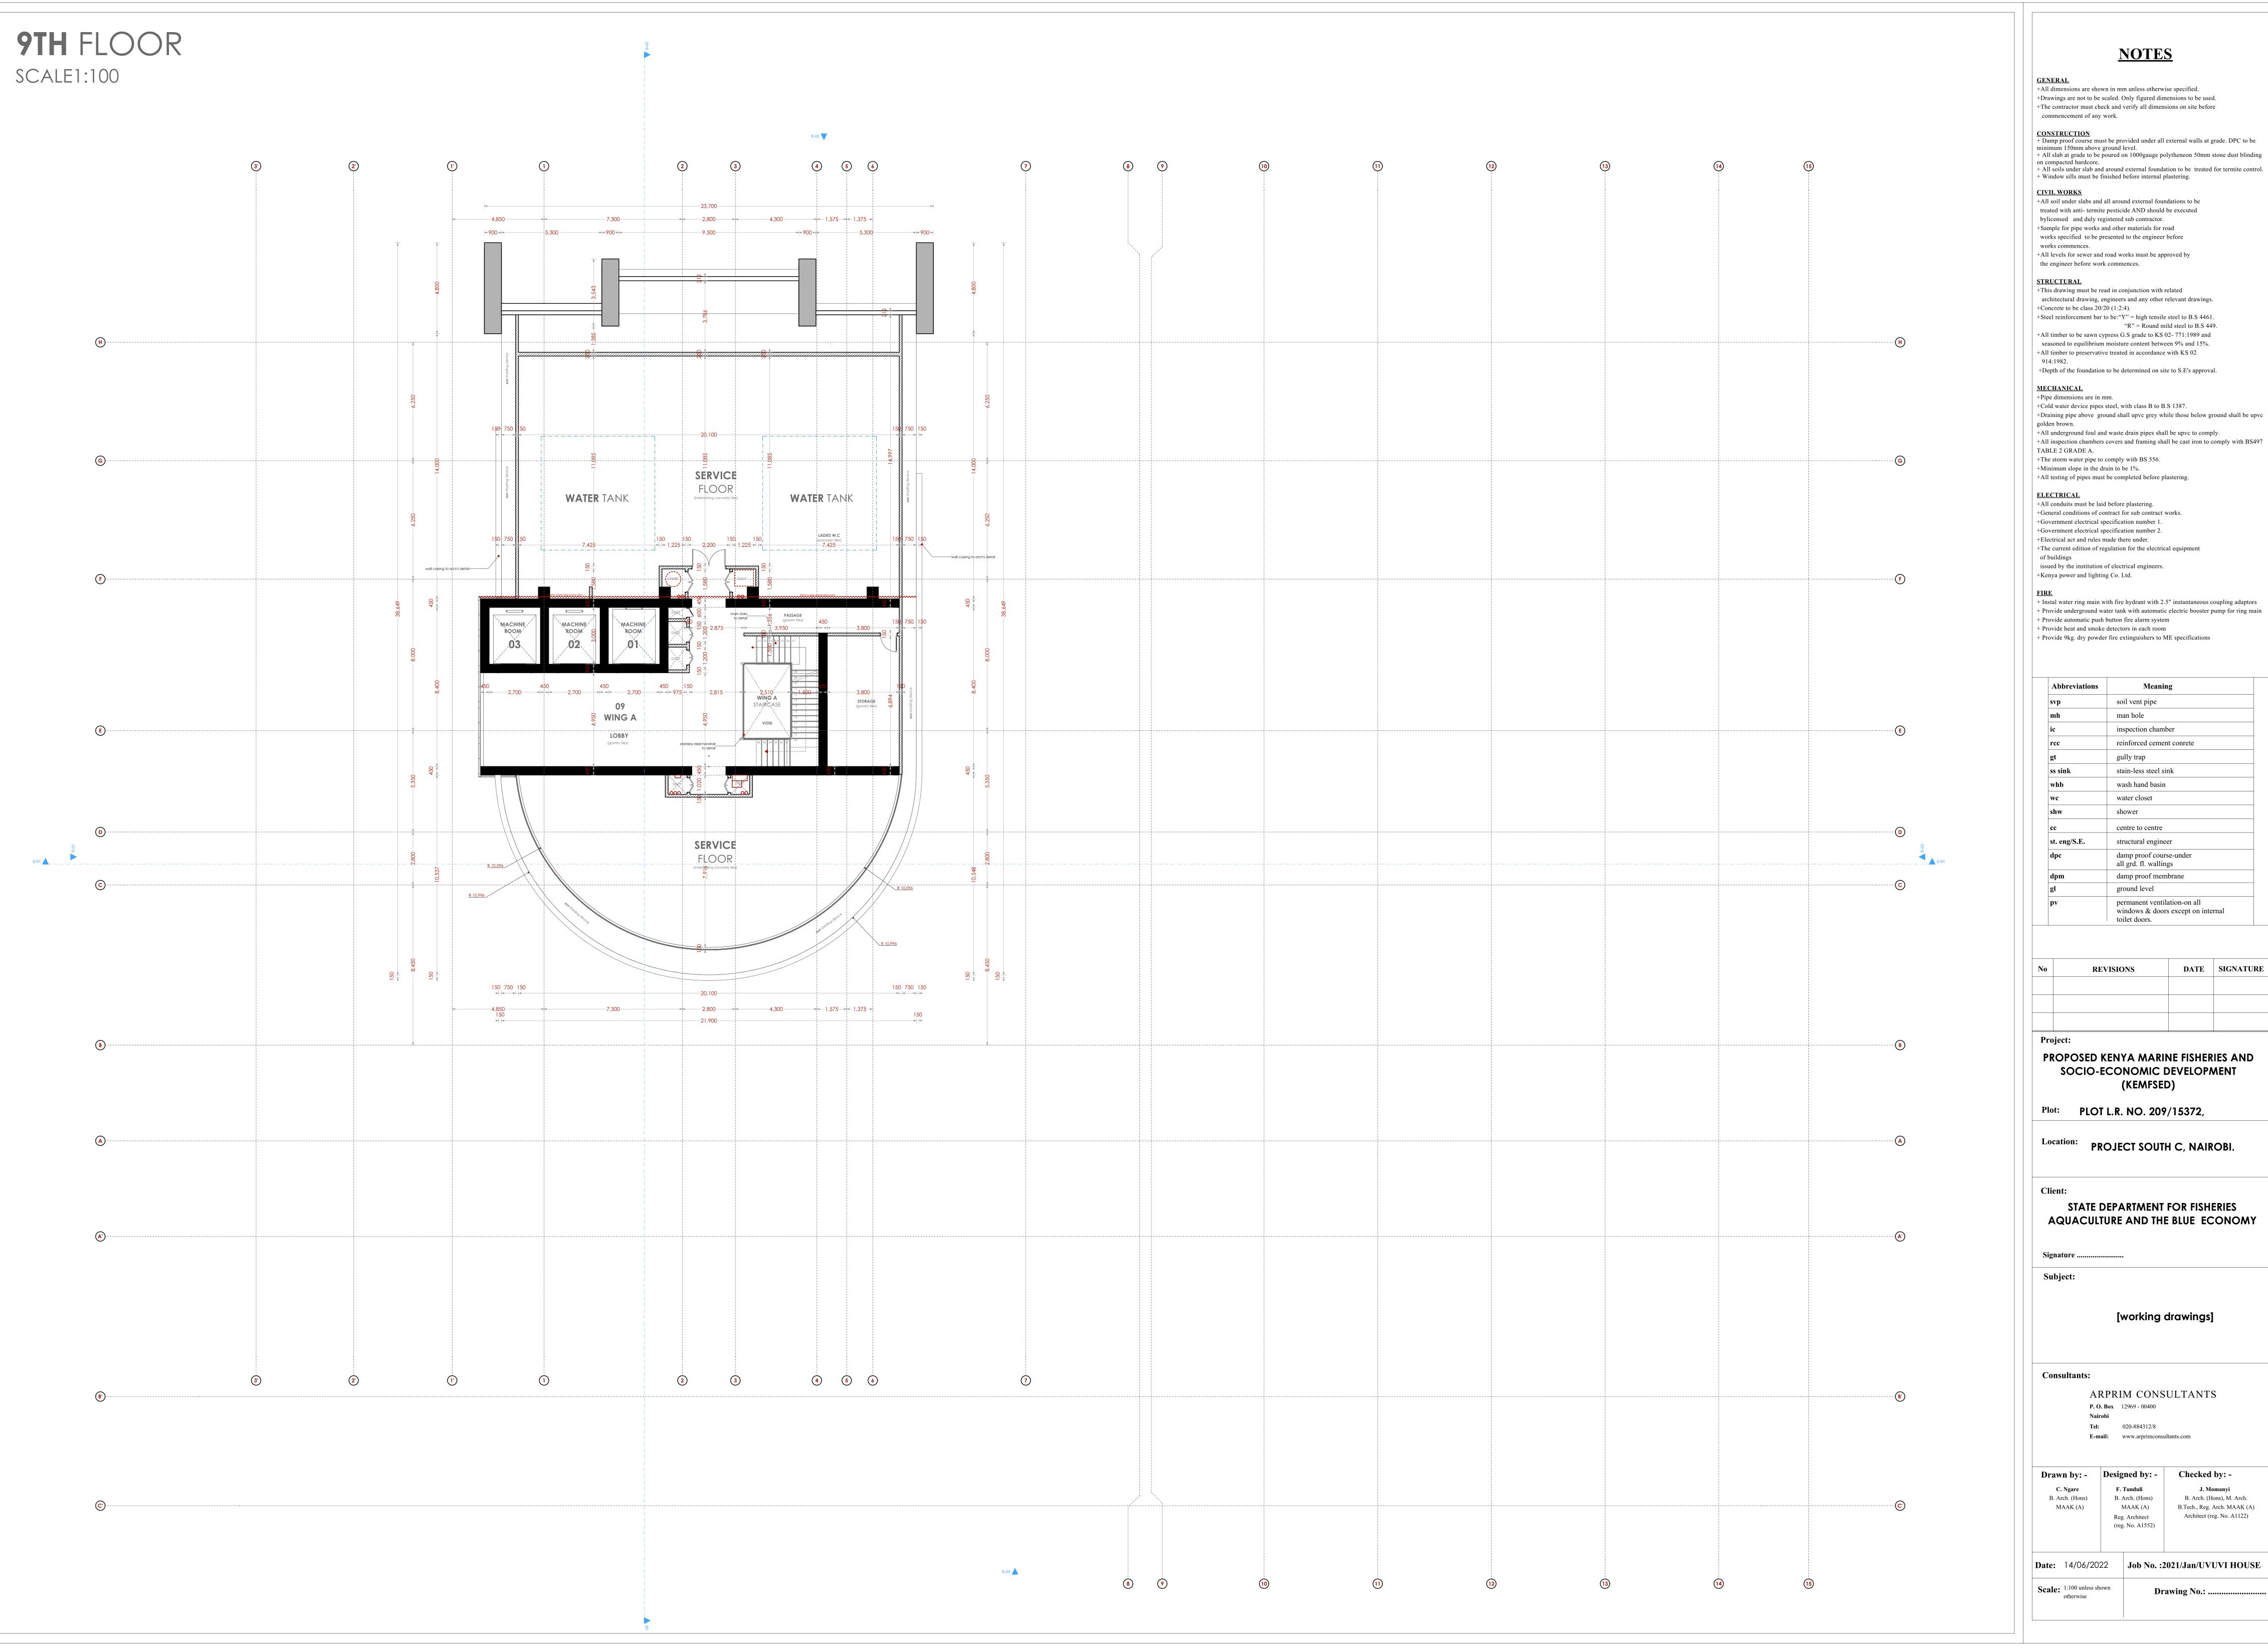+All testing of pipes must be completed before plastering.

ELECTRICAL +All conduits must be laid before plastering.

+General conditions of contract for sub contract works. +Government electrical specification number 1. +Government electrical specification number 2. +Electrical act and rules made there under.

issued by the institution of electrical engineers. +Kenya power and lighting Co. Ltd.

+ Instal water ring main with fire hydrant with 2.5" instantaneous coupling adaptors

+ Provide underground water tank with automatic electric booster pump for ring main + Provide automatic push button fire alarm system + Provide heat and smoke detectors in each room

+ Provide 9kg. dry powder fire extinguishers to ME specifications

Abbreviations	Meaning	
svp	soil vent pipe	
mh	man hole	
ic	inspection chamber	
rcc	reinforced cement conrete	
gt	gully trap	
ss sink	stain-less steel sink	
whb	wash hand basin	
wc	water closet	
shw	shower	
cc	centre to centre	
st. eng/S.E.	structural engineer	
dpc	damp proof course-under all grd. fl. wallings	
dpm	damp proof membrane	
gl	ground level	
pv	permanent ventilation-on all	

No	REVISIONS	DATE	SIGNATURE

toilet doors.

windows & doors except on internal

PROPOSED KENYA MARINE FISHERIES AND SOCIO-ECONOMIC DEVELOPMENT (KEMFSED)

Plot: PLOT L.R. NO. 209/15372,

Location: PROJECT SOUTH C, NAIROBI.

STATE DEPARTMENT FOR FISHERIES AQUACULTURE AND THE BLUE ECONOMY

[working drawings]

Consultants:

ARPRIM CONSULTANTS **P. O. Box** 12969 - 00400

Tel: 020-884312/8 E-mail: www.arprimconsultants.com


Drawn by: - Designed by: -Checked by: -B. Arch. (Hons), M. Arch. MAAK (A) B.Tech., Reg. Arch. MAAK (A)

(reg. No. A1552) **Date:** 14/06/2022 **Job No. :2021/Jan/UVUVI HOUSE**

Architect (reg. No. A1122)

Scale: 1:100 unless shown Drawing No.:

Reg. Architect

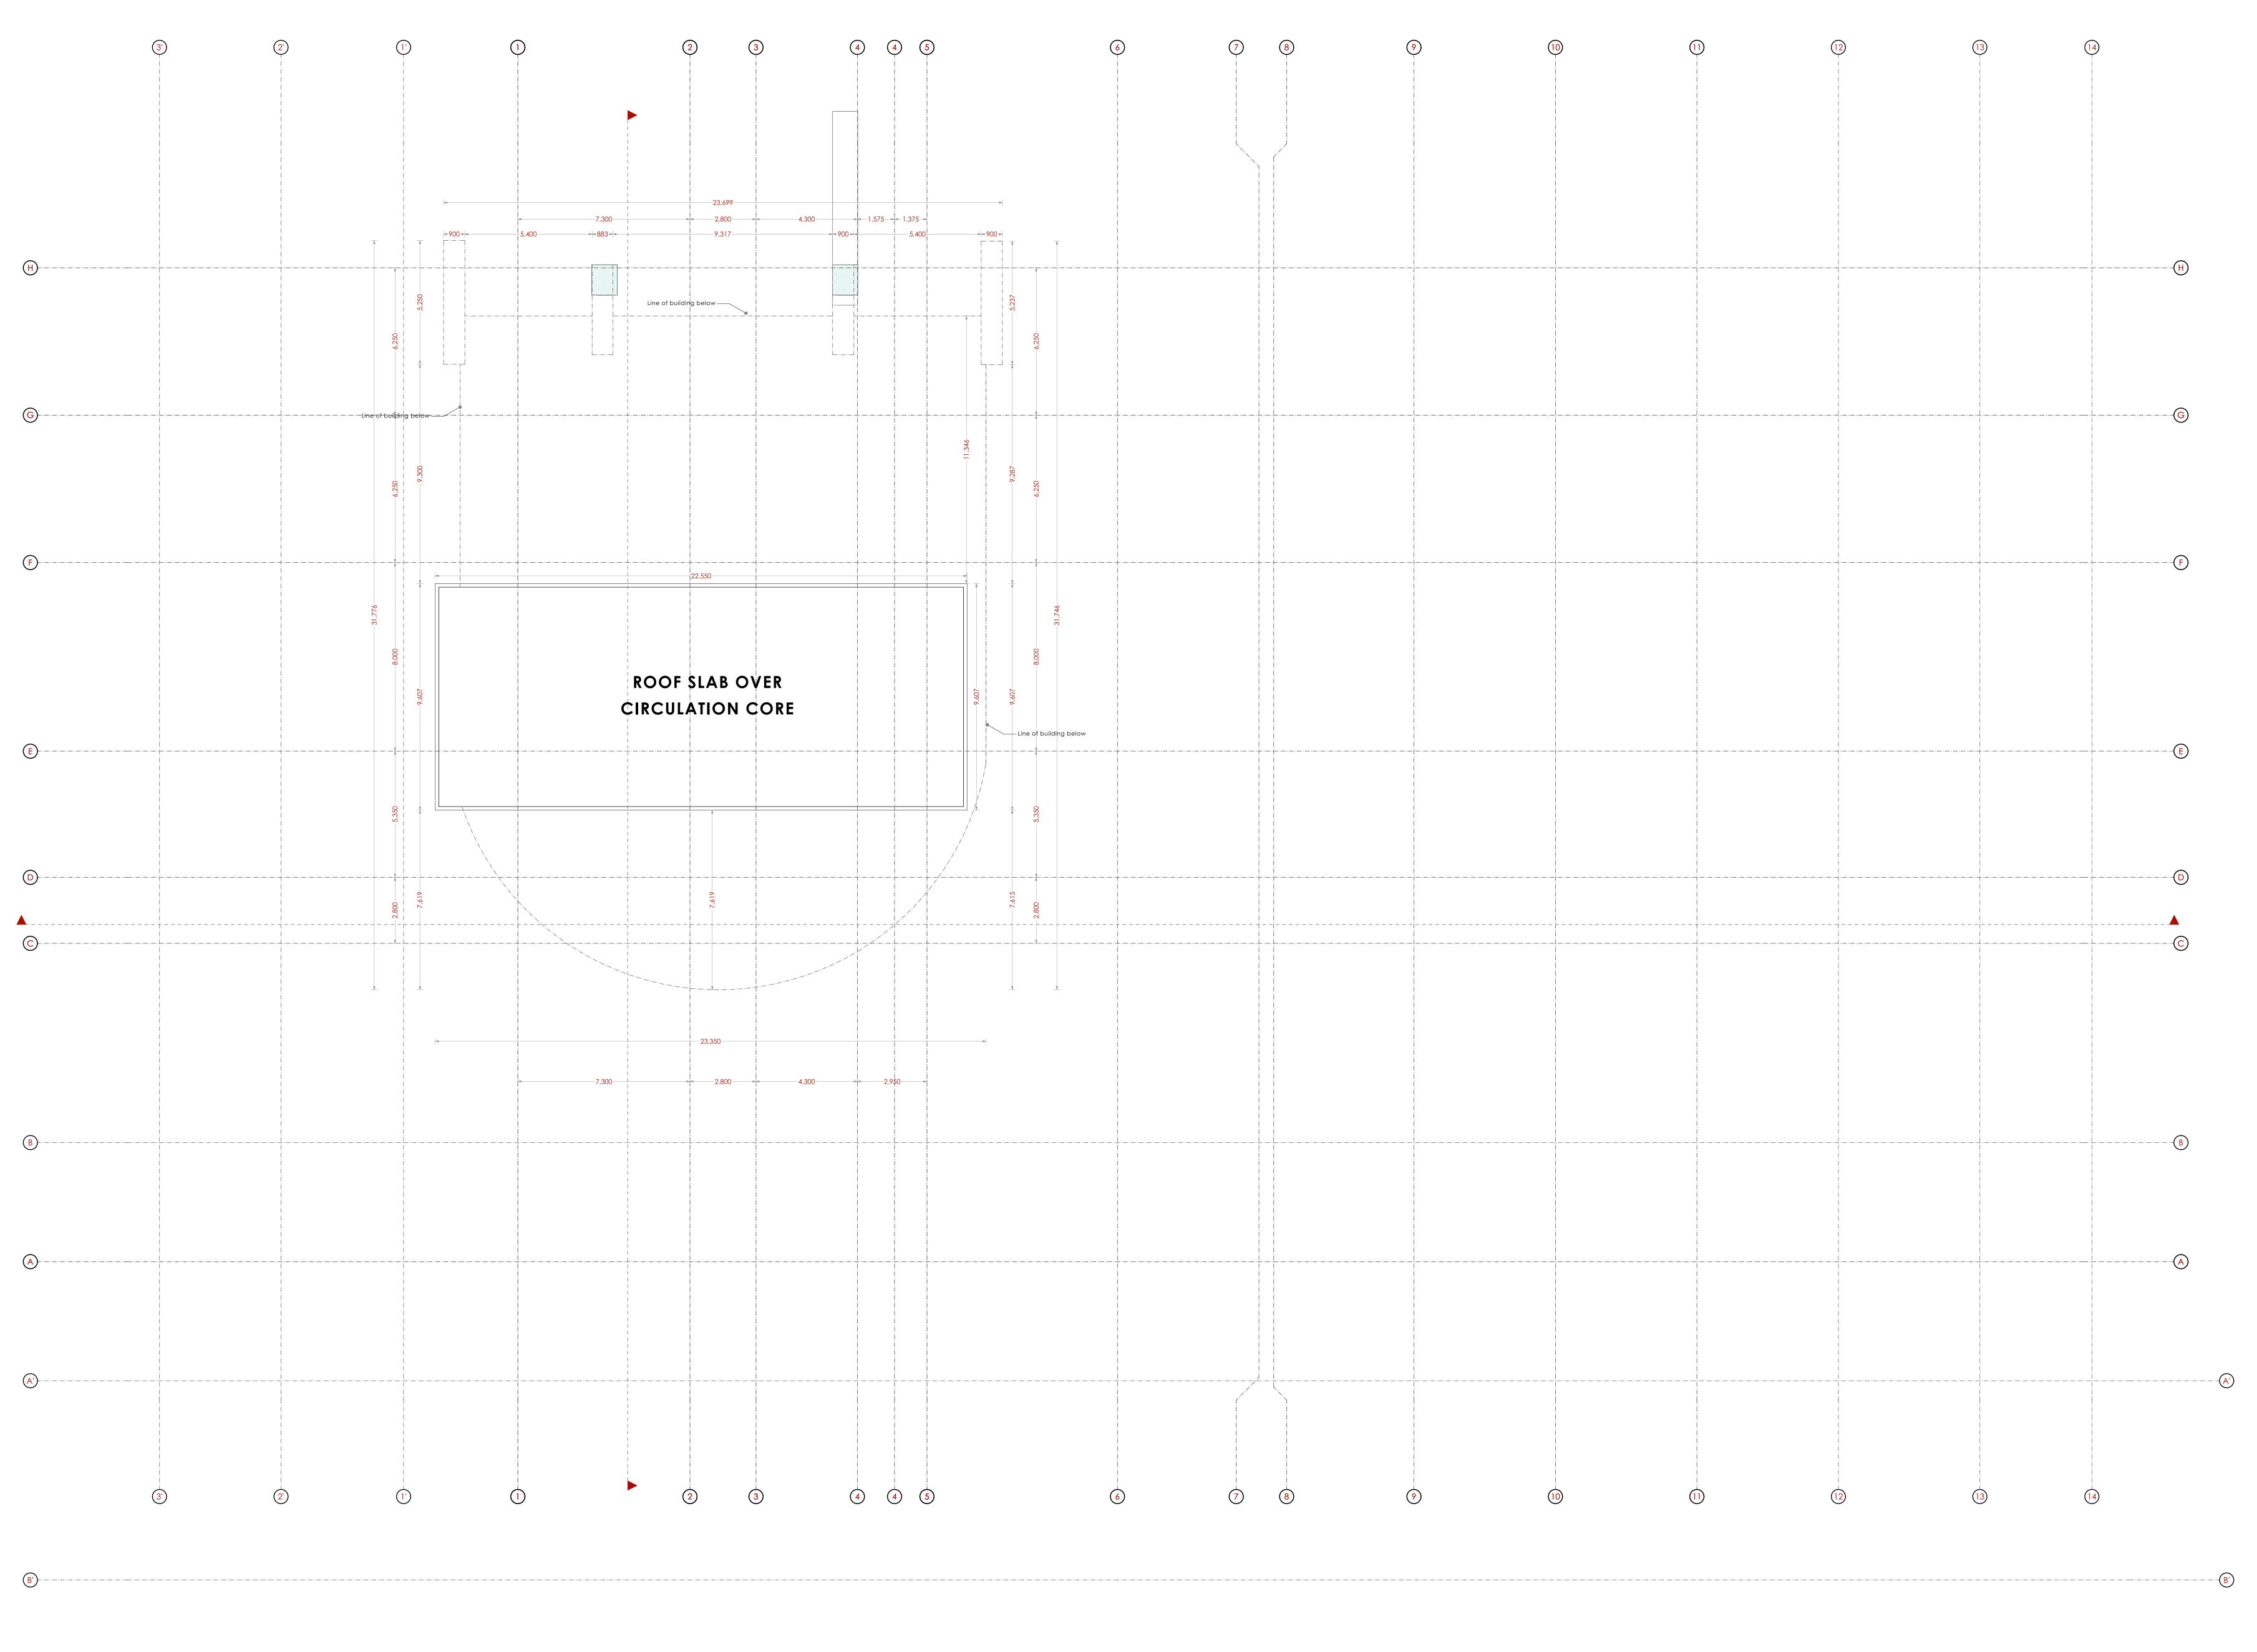

+All dimensions are shown in mm unless otherwise specified. +Drawings are not to be scaled. Only figured dimensions to be used. +The contractor must check and verify all dimensions on site before

commencement of any work.

CONSTRUCTION + Damp proof course must be provided under all external walls at grade. DPC to be minimum 150mm above ground level. + All slab at grade to be poured on 1000gauge polytheneon 50mm stone dust blinding on compacted hardcore. + All soils under slab and around external foundation to be treated for termite control.

CIVIL WORKS +All soil under slabs and all around external foundations to be

+ Window sills must be finished before internal plastering.

treated with anti- termite pesticide AND should be executed bylicensed and duly registered sub contractor. +Sample for pipe works and other materials for road works specified to be presented to the engineer before

works commences. +All levels for sewer and road works must be approved by the engineer before work commences.

STRUCTURAL

+This drawing must be read in conjunction with related architectural drawing, engineers and any other relevant drawings. +Concrete to be class 20/20 (1:2:4).

+Steel reinforcement bar to be:"Y" = high tensile steel to B.S 4461. "R" = Round mild steel to B.S 449. +All timber to be sawn cypress G.S grade to KS 02-771:1989 and

seasoned to equilibrium moisture content between 9% and 15%. +All timber to preservative treated in accordance with KS 02

914:1982. +Depth of the foundation to be determined on site to S.E's approval.

MECHANICAL

+Pipe dimensions are in mm. +Cold water device pipes steel, with class B to B.S 1387. +Draining pipe above ground shall upvc grey while those below ground shall be upvc

+All inspection chambers covers and framing shall be cast iron to comply with BS497

golden brown. +All underground foul and waste drain pipes shall be upvc to comply.

TABLE 2 GRADE A. +The storm water pipe to comply with BS 556.

+Minimum slope in the drain to be 1%. +All testing of pipes must be completed before plastering.

ELECTRICAL

+All conduits must be laid before plastering. +General conditions of contract for sub contract works. +Government electrical specification number 1.

+Government electrical specification number 2. +Electrical act and rules made there under. +The current edition of regulation for the electrical equipment

issued by the institution of electrical engineers.

+Kenya power and lighting Co. Ltd.

+ Instal water ring main with fire hydrant with 2.5" instantaneous coupling adaptors

+ Provide underground water tank with automatic electric booster pump for ring main + Provide automatic push button fire alarm system

+ Provide heat and smoke detectors in each room + Provide 9kg. dry powder fire extinguishers to ME specifications

Abbreviations	Meaning
svp	soil vent pipe
mh	man hole
ic	inspection chamber
rcc	reinforced cement conrete
gt	gully trap
ss sink	stain-less steel sink
whb	wash hand basin
wc	water closet
shw	shower
cc	centre to centre
st. eng/S.E.	structural engineer
dpc	damp proof course-under all grd. fl. wallings
dpm	damp proof membrane
gl	ground level

No	REVISIONS	DATE	SIGNATURE

toilet doors.

permanent ventilation-on all

windows & doors except on internal

PROPOSED KENYA MARINE FISHERIES AND SOCIO-ECONOMIC DEVELOPMENT (KEMFSED)

Plot: PLOT L.R. NO. 209/15372,

PROJECT SOUTH C, NAIROBI.

[working drawings]


Consultants:

MAAK (A) Reg. Architect

ELEVATION 01 **NOTES** SCALE1:100 +All dimensions are shown in mm unless otherwise specified. +Drawings are not to be scaled. Only figured dimensions to be used. +The contractor must check and verify all dimensions on site before commencement of any work. CONSTRUCTION + Damp proof course must be provided under all external walls at grade. DPC to be minimum 150mm above ground level. + All slab at grade to be poured on 1000gauge polytheneon 50mm stone dust blinding on compacted hardcore. + All soils under slab and around external foundation to be treated for termite control. + Window sills must be finished before internal plastering. 6,250 8,000 5,350 5,050 5,050 5,050 5,050 CIVIL WORKS +All soil under slabs and all around external foundations to be treated with anti- termite pesticide AND should be executed bylicensed and duly registered sub contractor. +Sample for pipe works and other materials for road works specified to be presented to the engineer before works commences. +All levels for sewer and road works must be approved by the engineer before work commences. **STRUCTURAL** +This drawing must be read in conjunction with related architectural drawing, engineers and any other relevant drawings. +Concrete to be class 20/20 (1:2:4). +Steel reinforcement bar to be:"Y" = high tensile steel to B.S 4461. "R" = Round mild steel to B.S 449. +All timber to be sawn cypress G.S grade to KS 02-771:1989 and seasoned to equilibrium moisture content between 9% and 15%. +All timber to preservative treated in accordance with KS 02 +Depth of the foundation to be determined on site to S.E's approval. **MECHANICAL** +Pipe dimensions are in mm. +Cold water device pipes steel, with class B to B.S 1387. MILD STEEL MAST +Draining pipe above ground shall upvc grey while those below ground shall be upvc **Sealant:** approved weatherseal paint golden brown. +All underground foul and waste drain pipes shall be upvc to comply. **Structure:** steel girders to S.E. detail +All inspection chambers covers and framing shall be cast iron to comply with BS497 TABLE 2 GRADE A. +The storm water pipe to comply with BS 556. +Minimum slope in the drain to be 1%. +All testing of pipes must be completed before plastering. ELECTRICAL +All conduits must be laid before plastering. +General conditions of contract for sub contract works. +Government electrical specification number 1. +Government electrical specification number 2. +Electrical act and rules made there under. +The current edition of regulation for the electrical equipment issued by the institution of electrical engineers. +Kenya power and lighting Co. Ltd. ALUCOBOND CLADDING ON RIGID STEEL FRAME see Architect's detail Alucobond composite panel: + Instal water ring main with fire hydrant with 2.5" instantaneous coupling adaptors + Provide underground water tank with automatic electric booster pump for ring main Nano self-cleansing aluminium composite + Provide automatic push button fire alarm system panel comprised of normal PE core, aluminium + Provide heat and smoke detectors in each room pane, primer paint, PVDF paint and finished in + Provide 9kg. dry powder fire extinguishers to ME specifications Nanometer paint. Panel to be 6mm thick with aluminium thickness of at least 0.5mm. Approved weatherseal silicon sealant. FACADE ELEMENTS; see Architect's detail Alucobond composite panel: Nano self-cleansing aluminium composite panel comprised of normal PE core, —aluminium pane, primer paint, PVDF paint and finished in Nanometer paint. Panel to be permanent ventilation-on all windows & doors except on internal 6mm thick with aluminium thickness of at least toilet doors. Approved weatherseal silicon sealant **CURTAIN WALL** Frameless glass curtain wall to Architect's detail: main frame: 150x75x3mm thick powder-coated aluminium sections mullions: 100x60x3mm thick powder-coated aluminium sections PROPOSED KENYA MARINE FISHERIES AND **Curtain glazing:** SOCIO-ECONOMIC DEVELOPMENT butt glazed, 10mm thick laminated glass (KEMFSED) comprising of 5mm thick self-cleansing as SGG Bioclean from saint-GoBain plus 5mm thick solar control glass-colour to approved sample Plot: PLOT L.R. NO. 209/15372, Approved black anti-bacterial silicon sealant PROJECT SOUTH C, NAIROBI. STATE DEPARTMENT FOR FISHERIES AQUACULTURE AND THE BLUE ECONOMY [working drawings] <u>RAILINGS</u> 900mm high stainless steel railing with 10mm thick butt-jointed tempered glass panels and 65mm dia. **Consultants:** stainless steel tube ,mounted on 300mm upstand ARPRIM CONSULTANTS Ground Floor +2,000 beam to arch's approval. **P. O. Box** 12969 - 00400 020-884312/8 E-mail: www.arprimconsultants.com Ground Level Checked by: -Designed by: -Drawn by: -B. Arch. (Hons), M. Arch. MAAK (A) B.Tech., Reg. Arch. MAAK (A) Architect (reg. No. A1122) Reg. Architect (reg. No. A1552) Job No. :2021/Jan/UVUVI HOUSE **Date:** 14/06/2022 Scale: 1:100 unless shown Drawing No.:

Abbreviations	Meaning	
svp	soil vent pipe	
mh	man hole	
ic	inspection chamber	
rcc	reinforced cement conrete	
gt	gully trap	
ss sink	stain-less steel sink	
whb	wash hand basin	
wc	water closet	
shw	shower	
cc	centre to centre	
st. eng/S.E.	structural engineer	
dpc	damp proof course-under all grd. fl. wallings	
dpm	damp proof membrane	
gl	ground level	
pv	permanent ventilation-on all	

No	REVISIONS	DATE	SIGNATURE	

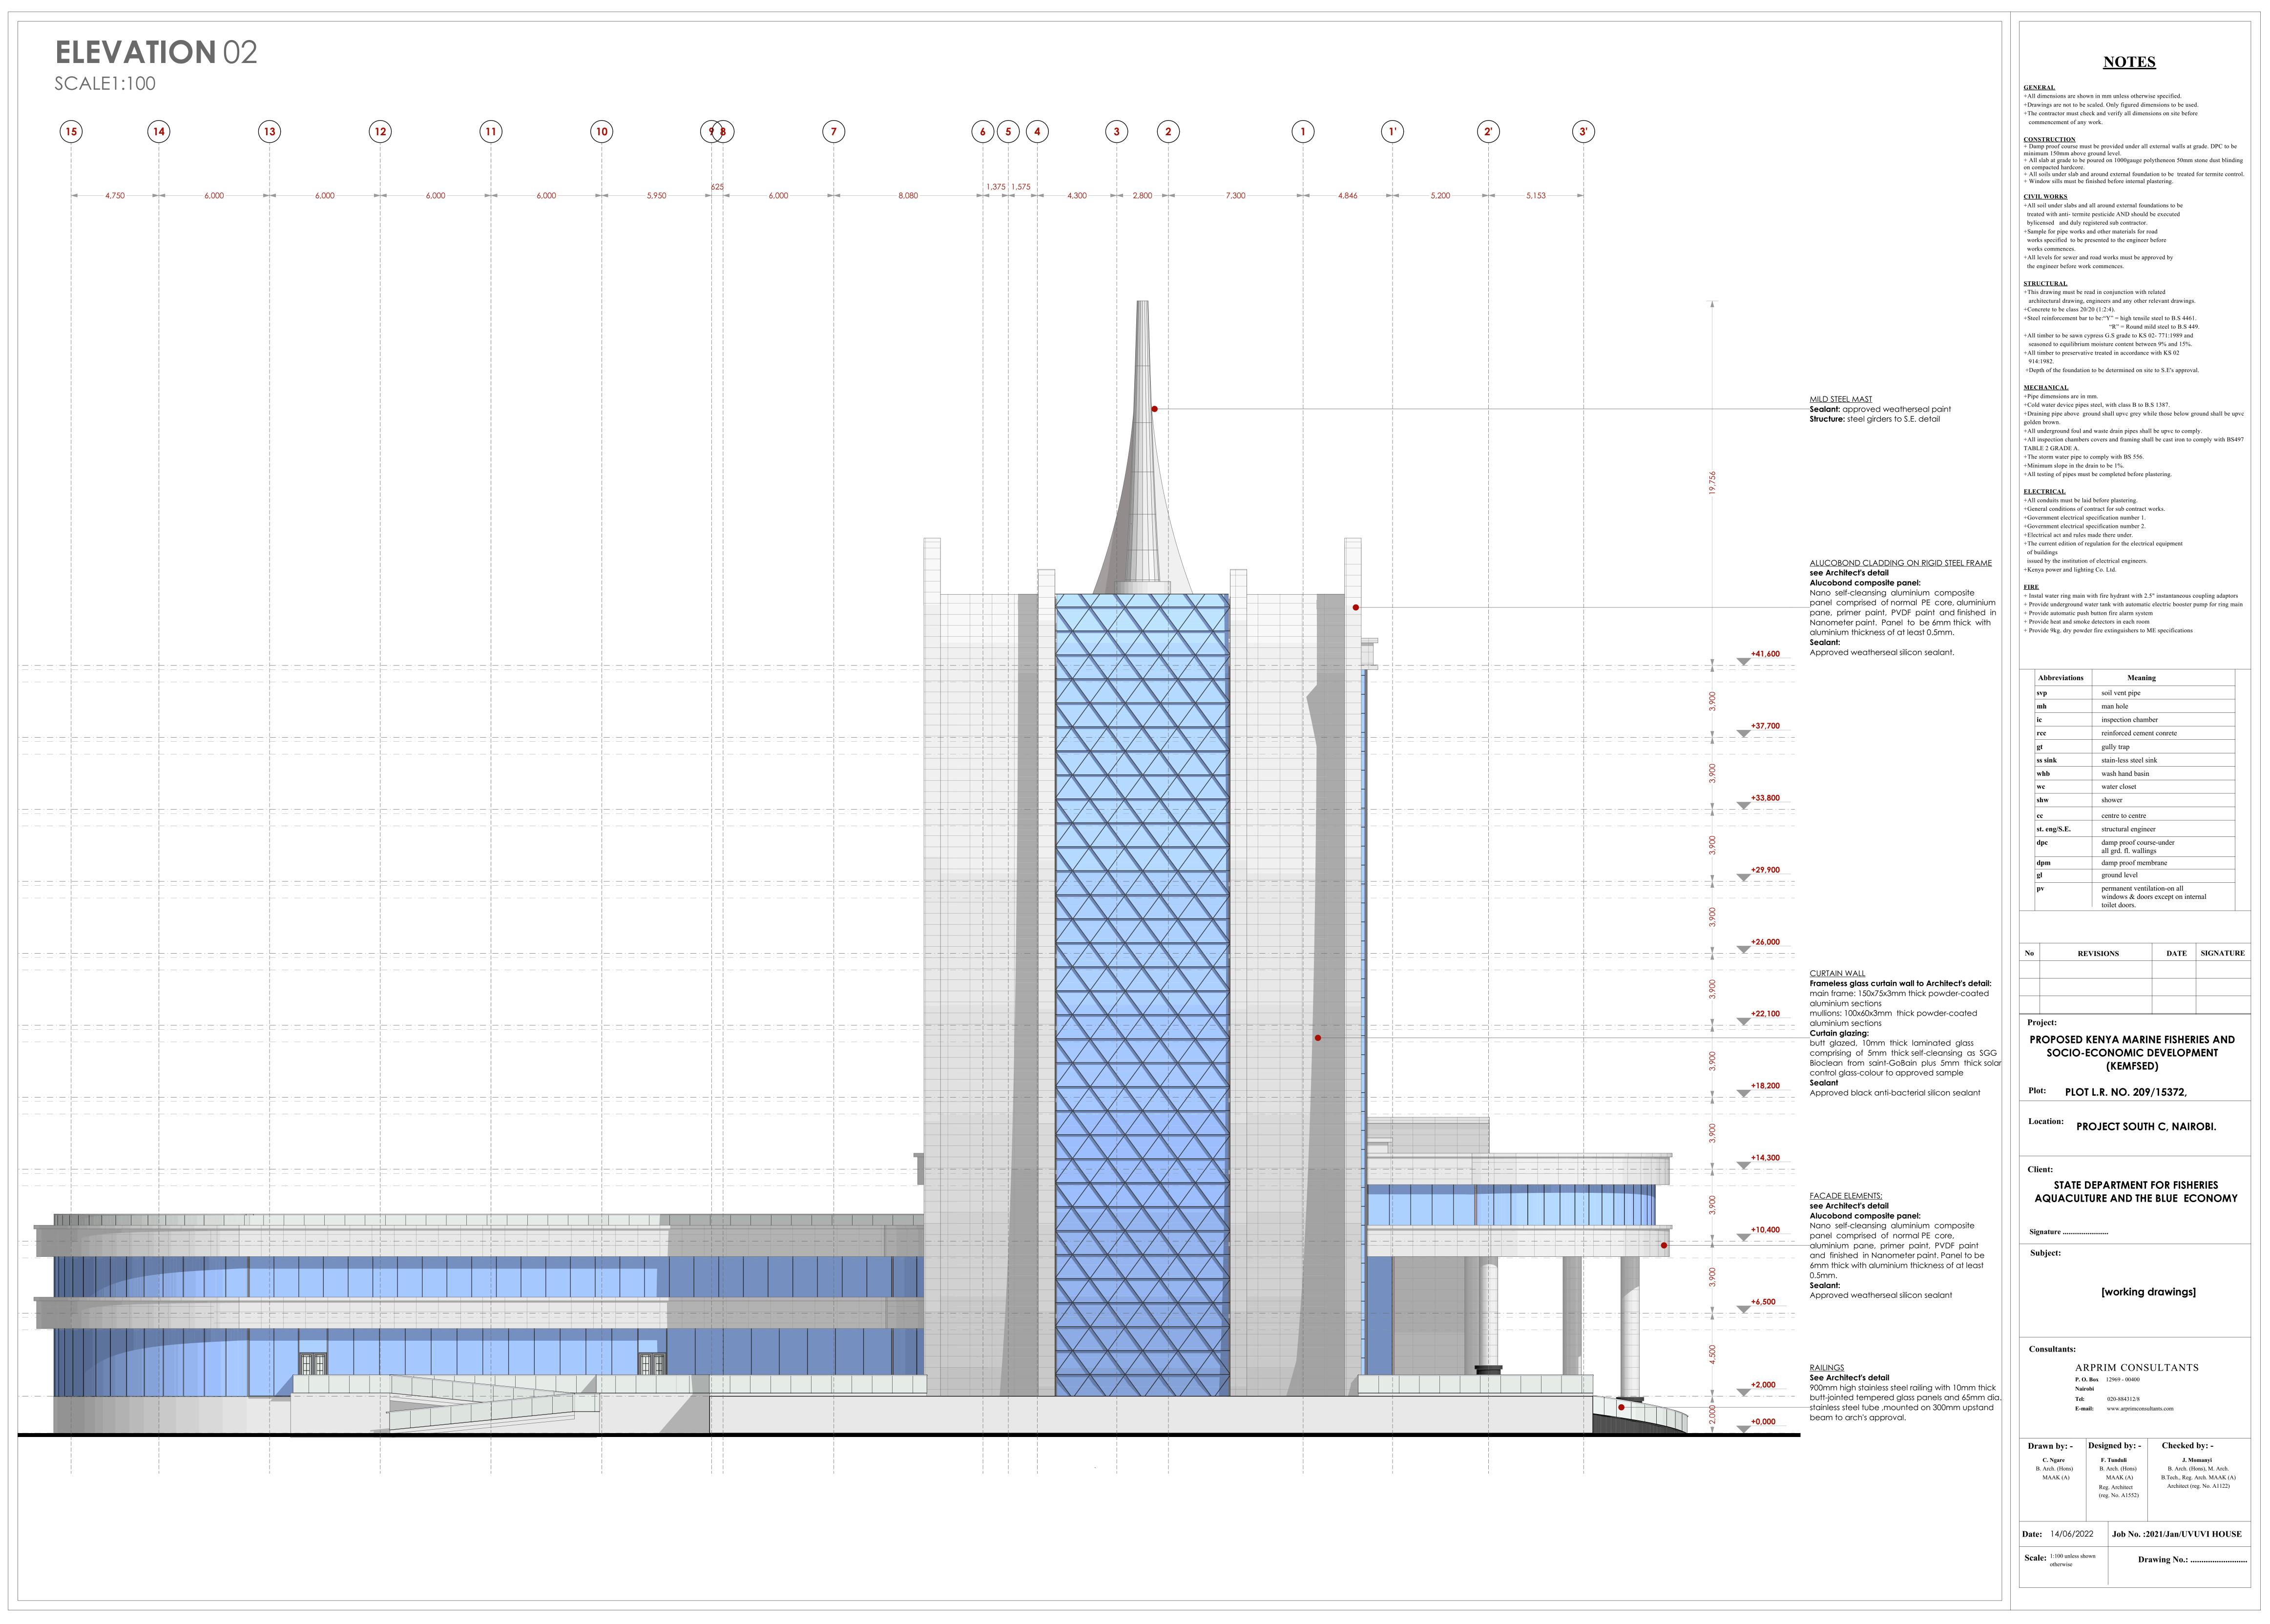

ELEVATION 03 SCALE1:100 2,800 5,350 MILD STEEL MAST **Sealant:** approved weatherseal paint Structure: steel girders to S.E. detail ALUCOBOND CLADDING ON RIGID STEEL FRAME see Architect's detail Alucobond composite panel: Nano self-cleansing aluminium composite panel comprised of normal PE core, aluminium pane, primer paint, PVDF paint and finished in Nanometer paint. Panel to be 6mm thick with aluminium thickness of at least 0.5mm. Approved weatherseal silicon sealant. FACADE ELEMENTS; see Architect's detail Alucobond composite panel: Nano self-cleansing aluminium composite panel comprised of normal PE core, -aluminium pane, primer paint, PVDF paint and finished in Nanometer paint. Panel to be 6mm thick with aluminium thickness of at least Approved weatherseal silicon sealant **CURTAIN WALL** Frameless glass curtain wall to Architect's detail: main frame: 150x75x3mm thick powder-coated aluminium sections mullions: 100x60x3mm thick powder-coated aluminium sections _Curtain glazing: butt glazed, 10mm thick laminated glass comprising of 5mm thick self-cleansing as SGG Bioclean from saint-GoBain plus 5mm thick solar control glass-colour to approved sample Approved black anti-bacterial silicon sealant <u>RAILINGS</u> 900mm high stainless steel railing with 10mm thick butt-jointed tempered glass panels and 65mm dia. stainless steel tube ,mounted on 300mm upstand Ground Floor +2,000 beam to arch's approval.

NOTES

+All dimensions are shown in mm unless otherwise specified. +Drawings are not to be scaled. Only figured dimensions to be used. +The contractor must check and verify all dimensions on site before commencement of any work.

CONSTRUCTION

on compacted hardcore.

+ Damp proof course must be provided under all external walls at grade. DPC to be minimum 150mm above ground level. + All slab at grade to be poured on 1000gauge polytheneon 50mm stone dust blinding

+ All soils under slab and around external foundation to be treated for termite control.

CIVIL WORKS +All soil under slabs and all around external foundations to be

treated with anti- termite pesticide AND should be executed bylicensed and duly registered sub contractor. +Sample for pipe works and other materials for road works specified to be presented to the engineer before works commences. +All levels for sewer and road works must be approved by the engineer before work commences.

+ Window sills must be finished before internal plastering.

STRUCTURAL

+This drawing must be read in conjunction with related architectural drawing, engineers and any other relevant drawings. +Concrete to be class 20/20 (1:2:4). +Steel reinforcement bar to be:"Y" = high tensile steel to B.S 4461. "R" = Round mild steel to B.S 449. +All timber to be sawn cypress G.S grade to KS 02-771:1989 and

+All timber to preservative treated in accordance with KS 02 +Depth of the foundation to be determined on site to S.E's approval.

seasoned to equilibrium moisture content between 9% and 15%.

MECHANICAL

golden brown.

+Pipe dimensions are in mm. +Cold water device pipes steel, with class B to B.S 1387. +Draining pipe above ground shall upvc grey while those below ground shall be upvc

+All underground foul and waste drain pipes shall be upvc to comply. +All inspection chambers covers and framing shall be cast iron to comply with BS497 TABLE 2 GRADE A.

+The storm water pipe to comply with BS 556. +Minimum slope in the drain to be 1%. +All testing of pipes must be completed before plastering.

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issued by the institution of electrical engineers. +Kenya power and lighting Co. Ltd.

+ Instal water ring main with fire hydrant with 2.5" instantaneous coupling adaptors + Provide underground water tank with automatic electric booster pump for ring main + Provide automatic push button fire alarm system

+ Provide heat and smoke detectors in each room + Provide 9kg. dry powder fire extinguishers to ME specifications

Abbreviations	Meaning
svp	soil vent pipe
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dpc	damp proof course-under all grd. fl. wallings
dpm	damp proof membrane
gl	ground level
pv	permanent ventilation-on all windows & doors except on internal

No	REVISIONS	DATE	SIGNATURE

PROPOSED KENYA MARINE FISHERIES AND SOCIO-ECONOMIC DEVELOPMENT (KEMFSED)

toilet doors.

Plot: PLOT L.R. NO. 209/15372,

PROJECT SOUTH C, NAIROBI.

STATE DEPARTMENT FOR FISHERIES AQUACULTURE AND THE BLUE ECONOMY

[working drawings]

Consultants:

ARPRIM CONSULTANTS **P. O. Box** 12969 - 00400 020-884312/8


E-mail: www.arprimconsultants.com


Checked by: -**Designed by: -**C. Ngare B. Arch. (Hons), M. Arch. MAAK (A) B.Tech., Reg. Arch. MAAK (A)


> Reg. Architect (reg. No. A1552)

Job No. :2021/Jan/UVUVI HOUSE Scale: 1:100 unless shown Drawing No.:

Architect (reg. No. A1122)

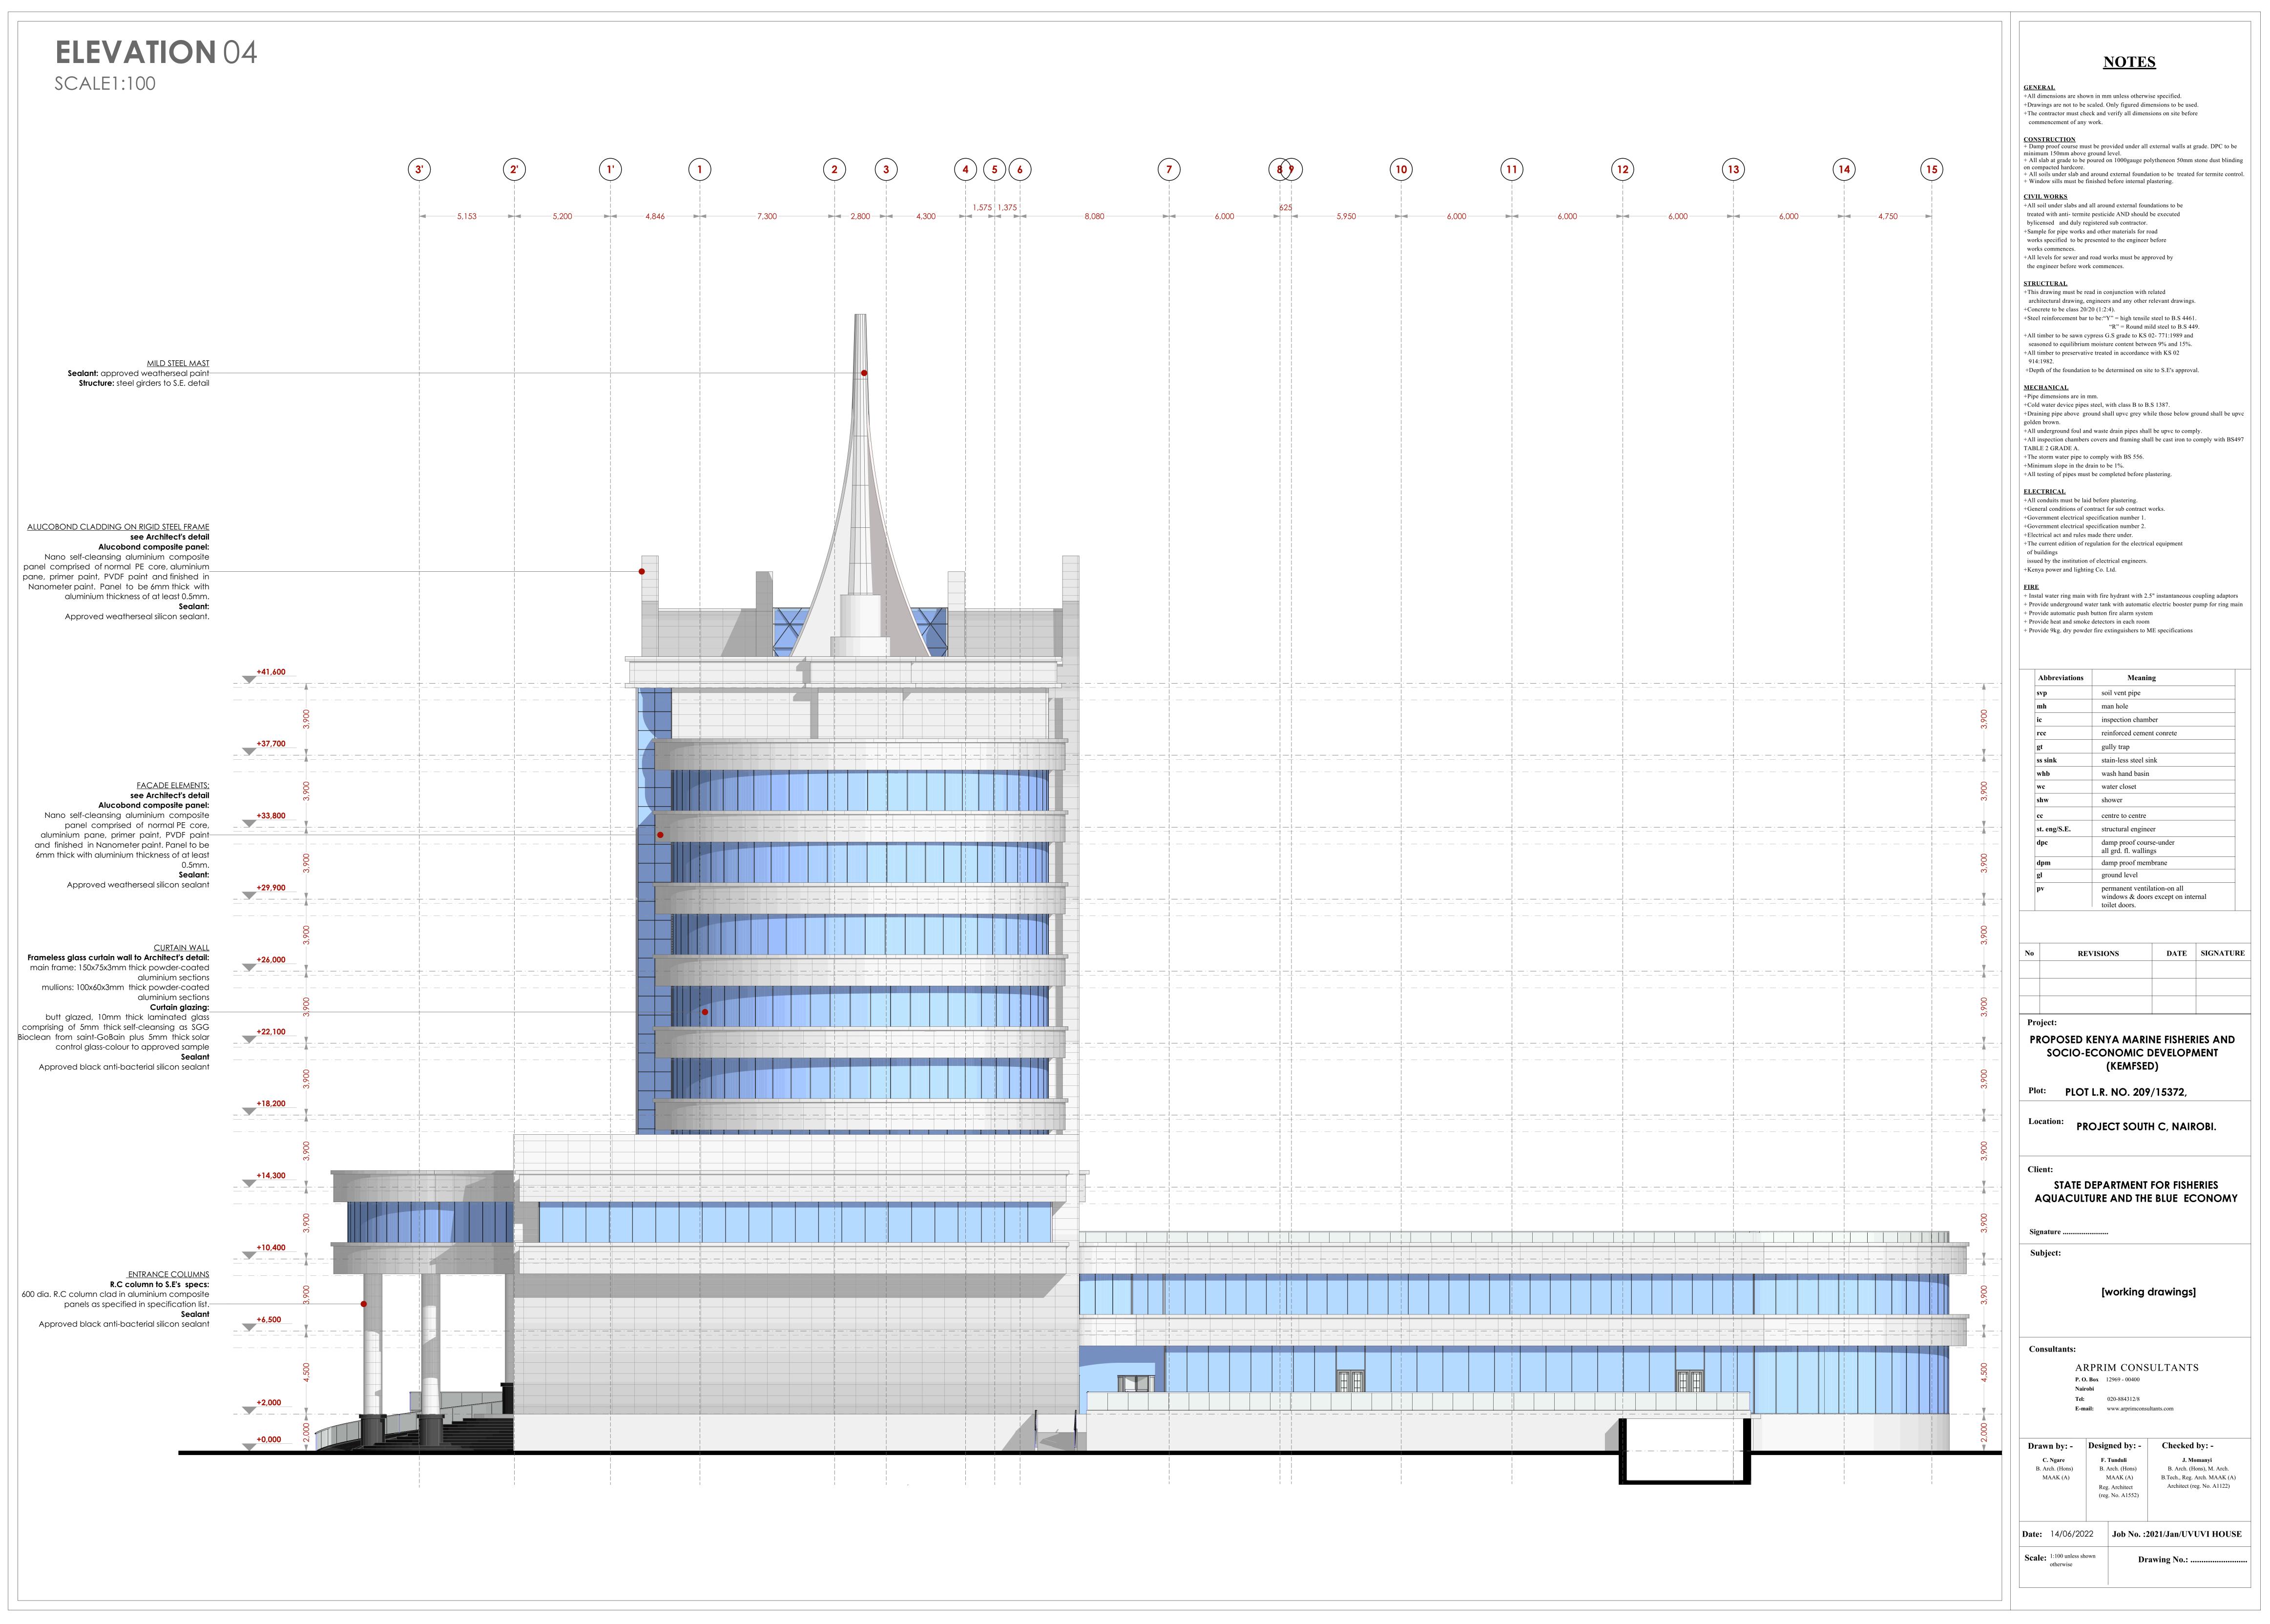

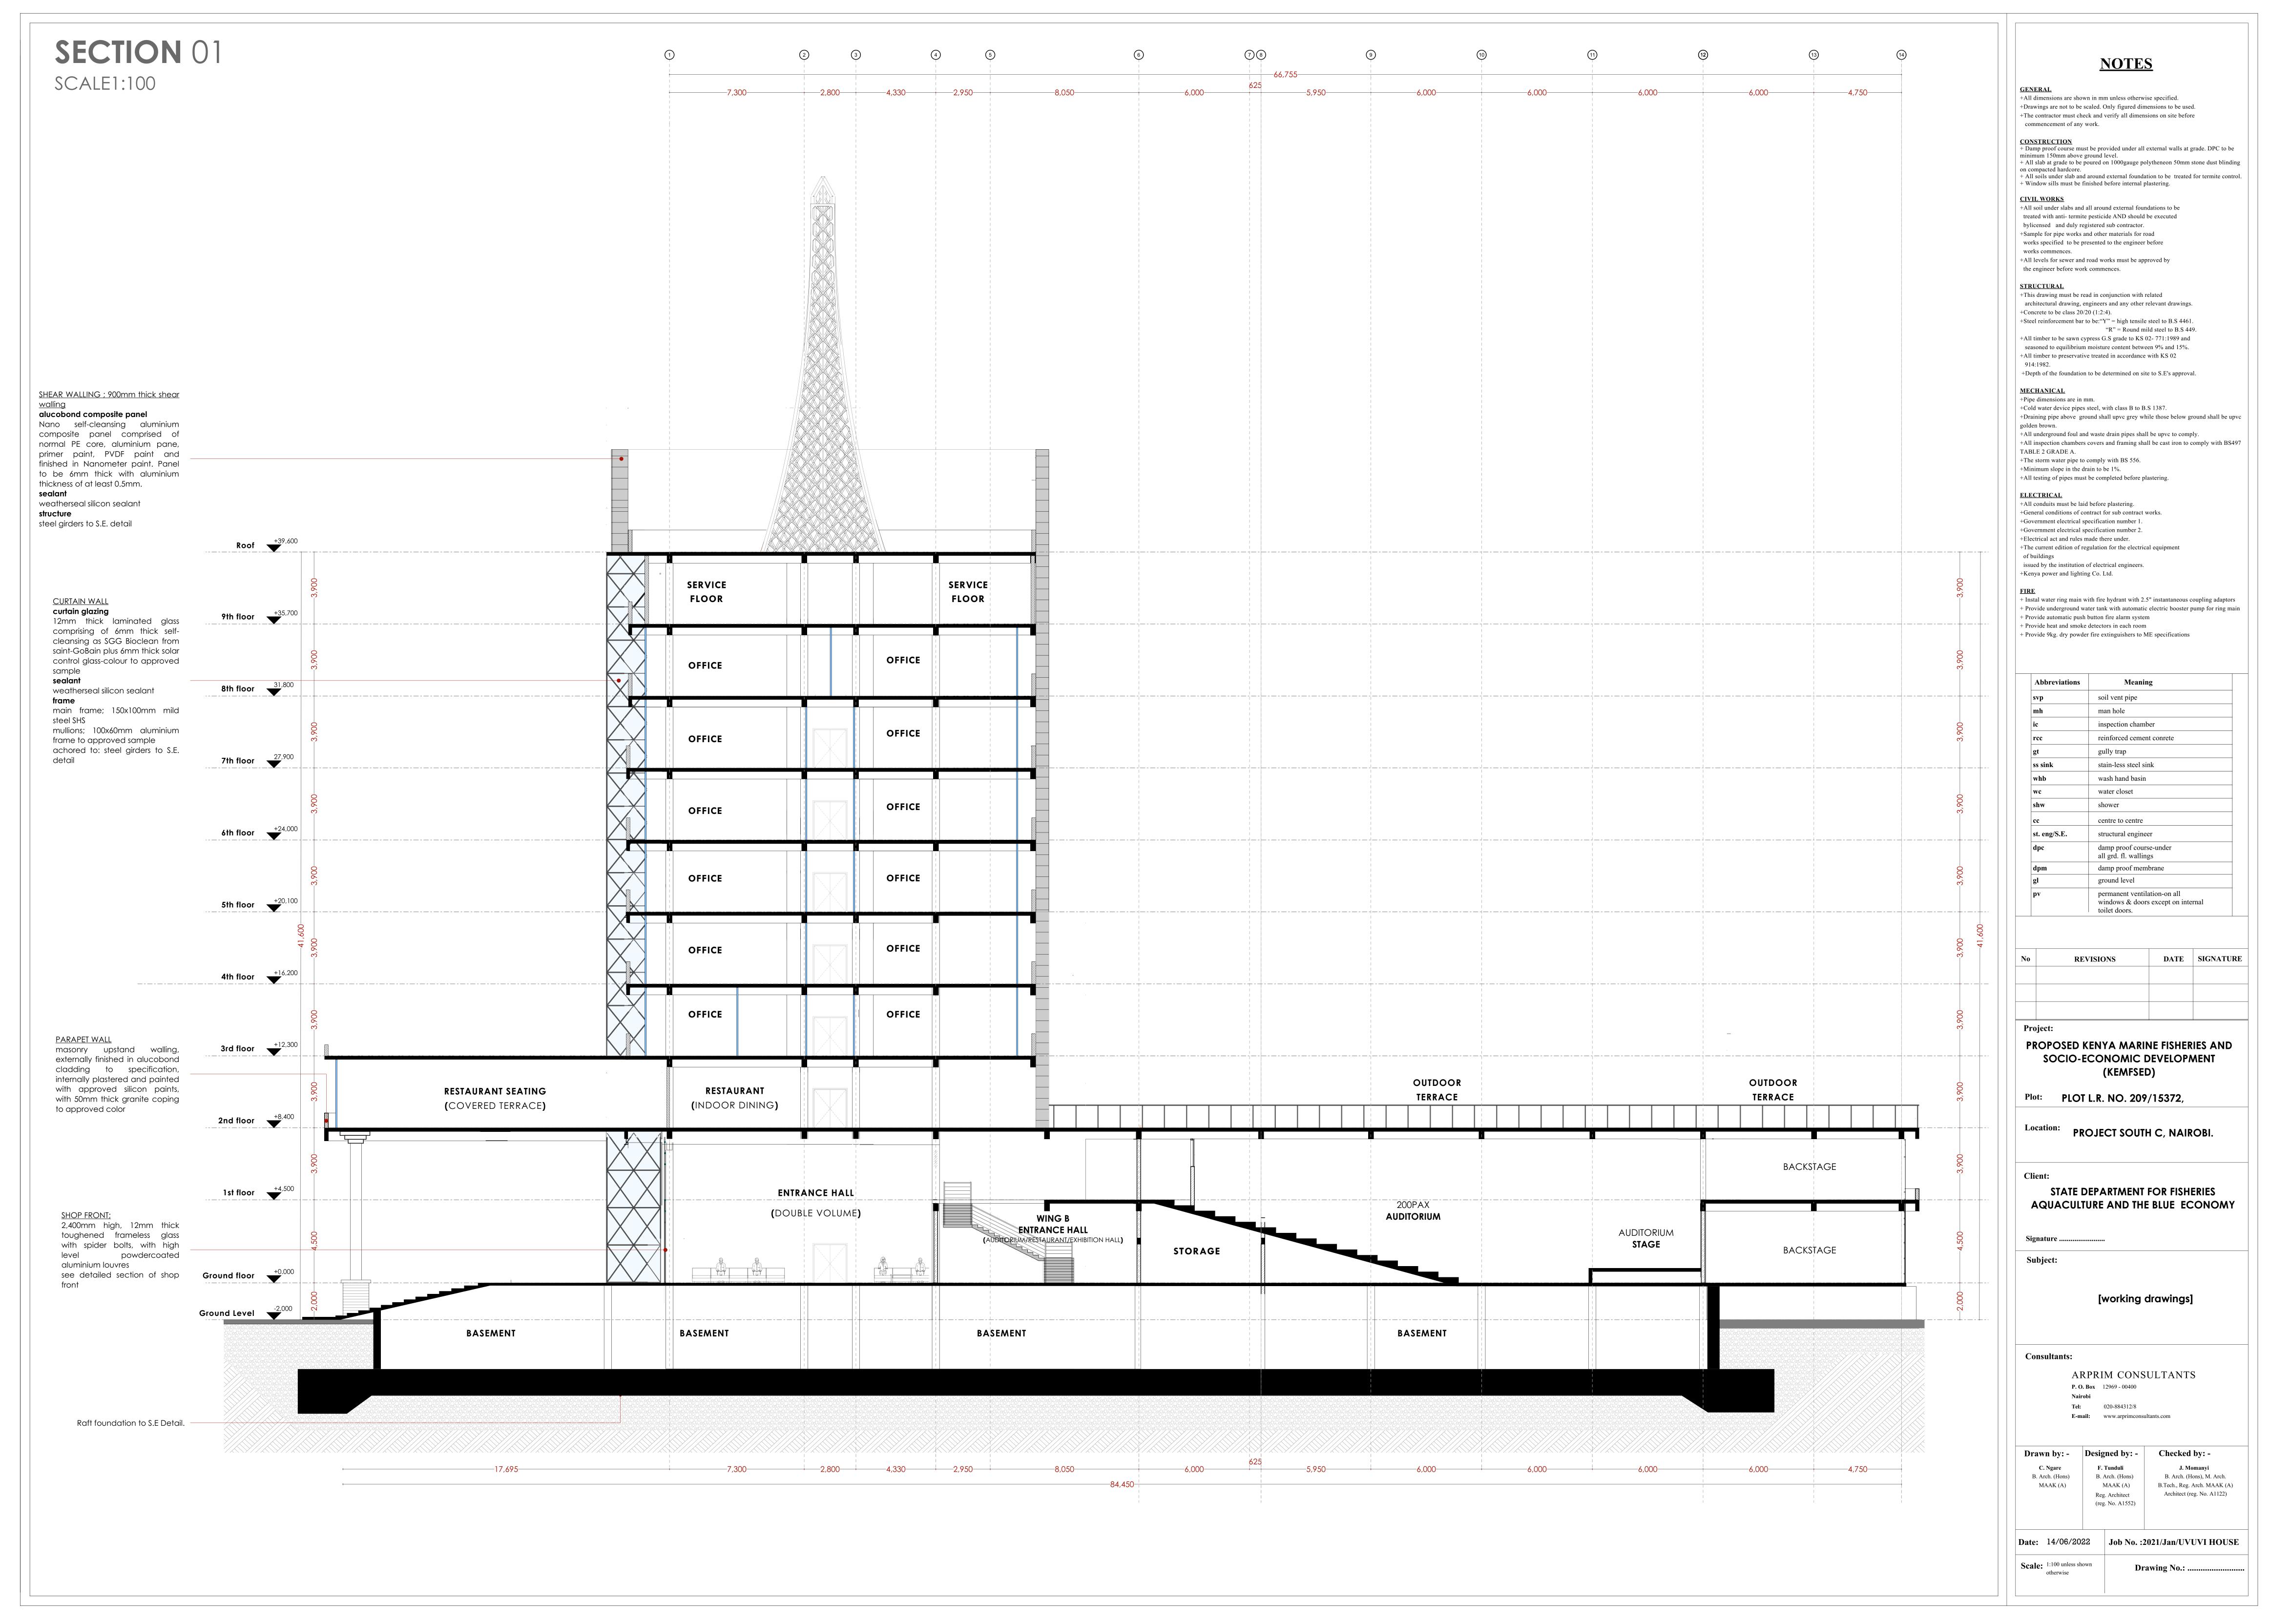

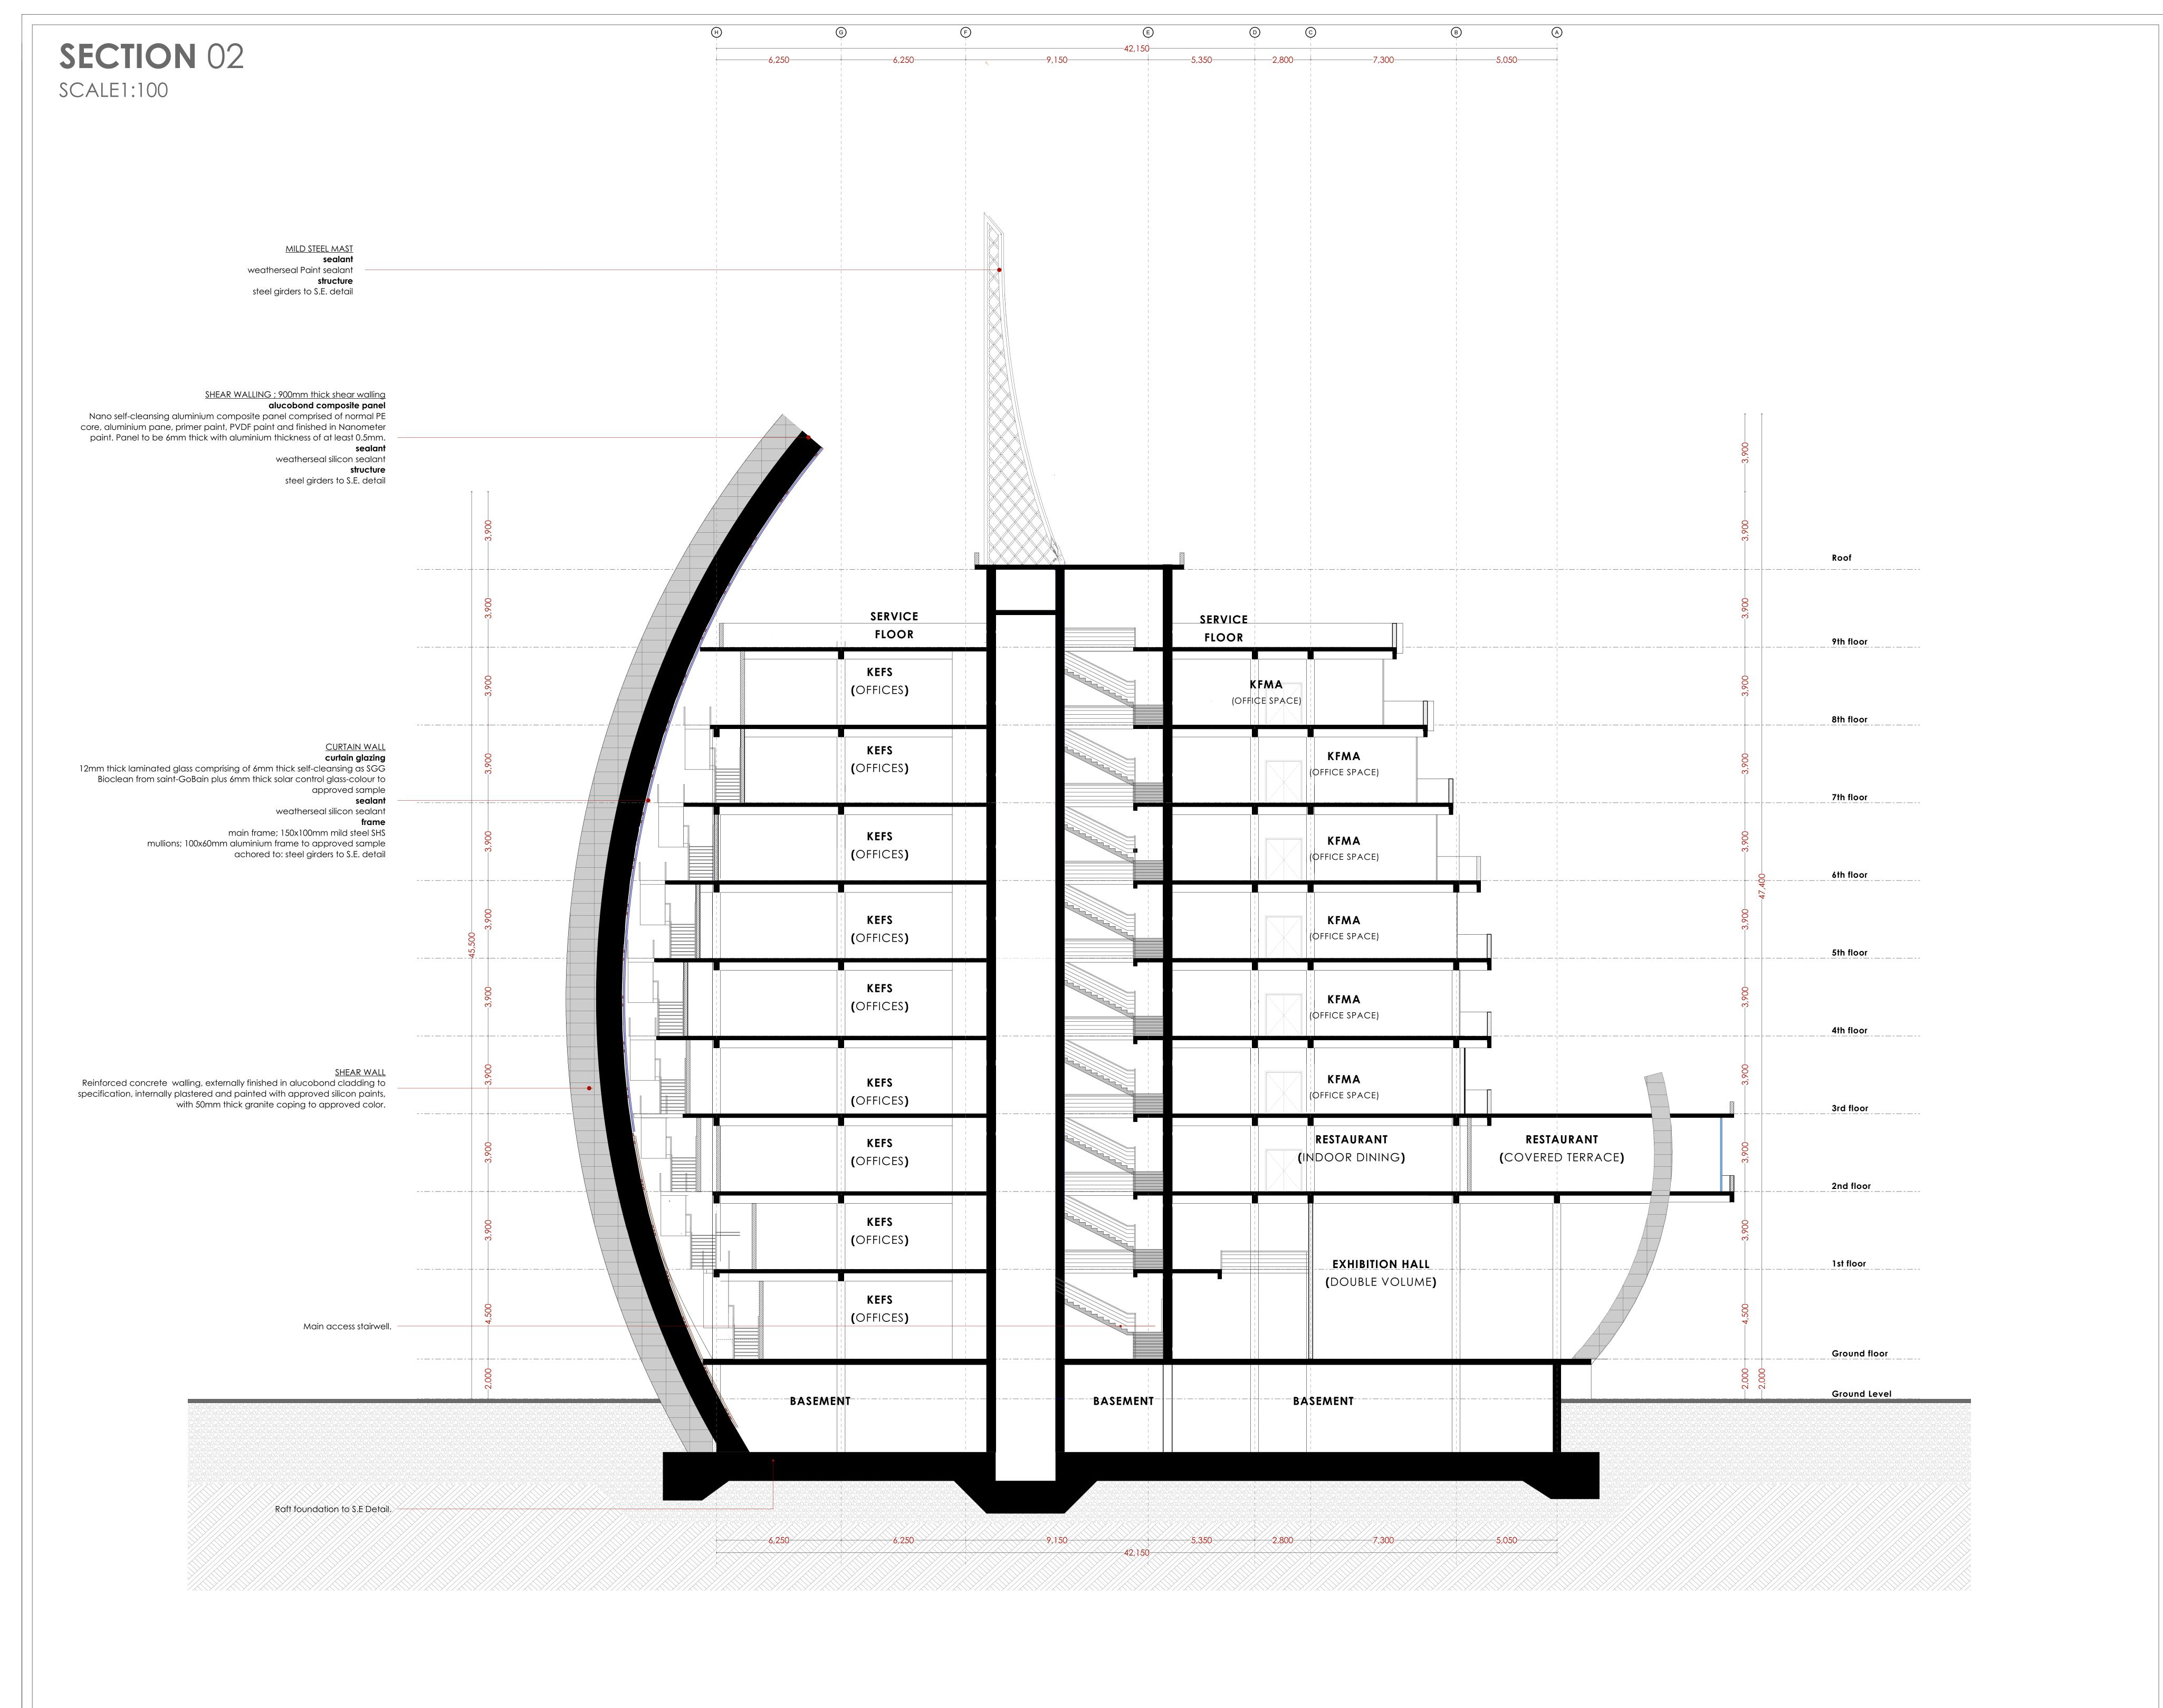

+All dimensions are shown in mm unless otherwise specified. +Drawings are not to be scaled. Only figured dimensions to be used. +The contractor must check and verify all dimensions on site before

CONSTRUCTION

commencement of any work. + Damp proof course must be provided under all external walls at grade. DPC to be minimum 150mm above ground level.

+ All soils under slab and around external foundation to be treated for termite control.

+ All slab at grade to be poured on 1000gauge polytheneon 50mm stone dust blinding on compacted hardcore.

CIVIL WORKS +All soil under slabs and all around external foundations to be treated with anti- termite pesticide AND should be executed bylicensed and duly registered sub contractor. +Sample for pipe works and other materials for road

+ Window sills must be finished before internal plastering.

works specified to be presented to the engineer before works commences. +All levels for sewer and road works must be approved by the engineer before work commences.

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+This drawing must be read in conjunction with related architectural drawing, engineers and any other relevant drawings. +Concrete to be class 20/20 (1:2:4). +Steel reinforcement bar to be:"Y" = high tensile steel to B.S 4461.

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+All timber to preservative treated in accordance with KS 02 914:1982.

+Depth of the foundation to be determined on site to S.E's approval.

MECHANICAL +Pipe dimensions are in mm. +Cold water device pipes steel, with class B to B.S 1387. +Draining pipe above ground shall upvc grey while those below ground shall be upvc

golden brown. +All underground foul and waste drain pipes shall be upvc to comply. +All inspection chambers covers and framing shall be cast iron to comply with BS497

TABLE 2 GRADE A. +The storm water pipe to comply with BS 556.

+Minimum slope in the drain to be 1%. +All testing of pipes must be completed before plastering.

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+Electrical act and rules made there under. +The current edition of regulation for the electrical equipment

issued by the institution of electrical engineers. +Kenya power and lighting Co. Ltd.

FIRE
+ Instal water ring main with fire hydrant with 2.5" instantaneous coupling adaptors + Provide underground water tank with automatic electric booster pump for ring main + Provide automatic push button fire alarm system

+ Provide heat and smoke detectors in each room + Provide 9kg. dry powder fire extinguishers to ME specifications

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cc	centre to centre
st. eng/S.E.	structural engineer
dpc	damp proof course-under all grd. fl. wallings

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damp proof membrane

permanent ventilation-on all windows & doors except on internal

ground level

toilet doors.

PROPOSED KENYA MARINE FISHERIES AND SOCIO-ECONOMIC DEVELOPMENT (KEMFSED)

Plot: PLOT L.R. NO. 209/15372,

Location: PROJECT SOUTH C, NAIROBI.

STATE DEPARTMENT FOR FISHERIES AQUACULTURE AND THE BLUE ECONOMY

Signature

[working drawings]

Consultants:

ARPRIM CONSULTANTS **P. O. Box** 12969 - 00400

Tel: 020-884312/8

E-mail: www.arprimconsultants.com

Designed by: - Checked by: -B. Arch. (Hons), M. Arch. B. Arch. (Hons)

MAAK (A)

Reg. Architect

(reg. No. A1552)

Date: 14/06/2022 Job No. :2021/Jan/UVUVI HOUSE

Drawing No.:

B.Tech., Reg. Arch. MAAK (A) Architect (reg. No. A1122)